


VICINITY MAP
 SCALE: 1"=2,000'
 ADC MAP COORDINATE: MAP 28, GRID 5E

- LEGEND:**
- PROPERTY LINE
 - - - RIGHT-OF-WAY LINE
 - - - ADJACENT PROPERTY LINE
 - - - EXISTING PAVING
 - - - EXISTING UTILITY POLE
 - - - EXISTING 10' CONTOUR
 - - - EXISTING 2' CONTOUR
 - - - EXISTING TREETLINE
 - - - CENTERLINE OF EXISTING STREAM
 - EXISTING SPECIMEN TREE TO REMAIN
 - EXISTING WETLANDS
 - ▨ PROPOSED SIDEWALK
 - ▨ PROPOSED TREETLINE
 - ▨ PROPOSED CURB
 - ▨ PROPOSED 10' CONTOUR
 - ▨ PROPOSED 2' CONTOUR
 - ▨ PROPOSED MICRO-BIORETENTION FACILITY
 - PROPOSED STREET LIGHT
 - PROPOSED STREET SIGN

**CASCADE RIDGE ZONED R-ED
 HOWATD COUNTY PLANNING BOARD EXHIBIT
 HOWATD COUNTY ZONING REGULATIONS SECTION 107.0.F**

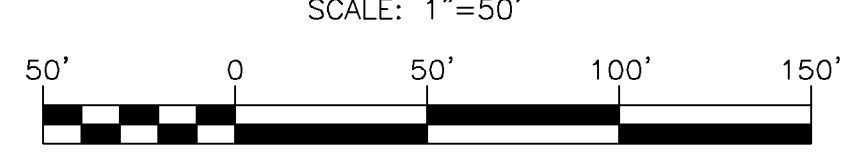

OWNER/DEVELOPER
 JOHN NEEDS
 7330 GREEN DRAKE ROAD
 ELK RIDGE, MD 21075
 (410) 869-0134

NO.	REVISION	DATE

PRELIMINARY EQUIVALENT SKETCH PLAN
PLANNING BOARD EXHIBIT
CASCADE RIDGE
 LOTS 1-18 AND OPEN SPACE LOTS 19 & 20
 7330 GREEN DRAKE ROAD
 ELK RIDGE, MD 21075

PARCEL: 474
 TAX MAP: 31 GRID: 11
 1ST ELECTION DISTRICT

ZONED: R-ED
 L 362 / F 260
 HOWARD COUNTY, MARYLAND

VOGEL ENGINEERING
 +
TIMMONS GROUP
 3300 NORTH RIDGE ROAD, SUITE 110, ELLICOTT CITY, MD 21043
 P: 410.461.7666 F: 410.461.8961 www.timmons.com



PROFESSIONAL CERTIFICATE
 I HEREBY CERTIFY THAT THESE DOCUMENTS
 WERE PREPARED OR APPROVED BY ME, AND
 THAT I AM A DULY LICENSED PROFESSIONAL
 ENGINEER UNDER THE LAWS OF THE STATE
 OF MARYLAND, LICENSE NO. 18183
 EXPIRATION DATE: 09-27-2022

DESIGN BY: RHV
 DRAWN BY: KG
 CHECKED BY: RHV
 DATE: MARCH 2021
 SCALE: AS SHOWN
 W.O. NO.: 42148

GENERAL NOTES

- 1. PROJECT BACKGROUND: SUBDIVISION NAME: CASCADE RIDGE - TAX MAP 31 GRID 11 - SECTION 19A - LOT/PARCEL - ZONING - ZB/BA REFERENCE - ELECTION DISTRICT - TOTAL TRACT AREA - SECTION/AREA - NUMBER OF PROPOSED LOTS - NET AREA OF PROJECT - AREA OF PROPOSED SFD - AREA OF PROPOSED SFA - AREA OF R/W DEDICATION - AREA OF PROPOSED ROAD R/W - OPEN SPACE REQ. - OPEN SPACE PROVIDED - MAX. PERMITTED DENSITY - PUBLIC WATER & SEWER - DPZ REF.'S

NET TRACT AREA

GROSS AREA = 9.085 AC
AREA OF 100 YEAR FLOODPLAIN = 0.51 AC
AREA OF STEEP SLOPES (25% GREATER) = 0.053 AC
NET AREA = 8.772 AC

APPROVAL OF THESE PLANS DOES NOT GRANT PERMISSION FOR OFFSITE DISTURBANCE. AUTHORIZATION IS REQUIRED FROM THE OWNER PRIOR TO ANY DISTURBANCE. THIS REQUIREMENT REMAINS THE SAME FOR ITEMS LOCATED WITHIN OFFSITE PUBLIC EASEMENTS.

NOTE:

1. ALL WATER CONNECTIONS SHALL BE 1-1/2" WITH 1" OUTSIDE METER SETTINGS, UNLESS OTHERWISE NOTED. REFER TO HOWARD COUNTY DETAILS W-3.28 OUTSIDE METER SETTINGS.

PRELIMINARY EQUIVALENT SKETCH PLAN
CASCADE RIDGE

LOTS 1-16 AND OPEN SPACE LOTS 17 - 19


PARCEL 474 (L. 362 / F. 260)
7330 GREEN DRAKE RD
ELKCRIDGE, MD 21075

BENCHMARKS

HOWARD COUNTY CONTROL STATION 31EF (CONC. MON.) N 571267.917 E 1376907.417 ELEV. 469.471
HOWARD COUNTY CONTROL STATION 0081 (CONC. MON.) N 572355.338 E 1377504.092 ELEV. 477.92

COORDINATE TABLE

Table with columns: POINT, NORTHING, EASTING. Lists coordinates for points 120 through 333.

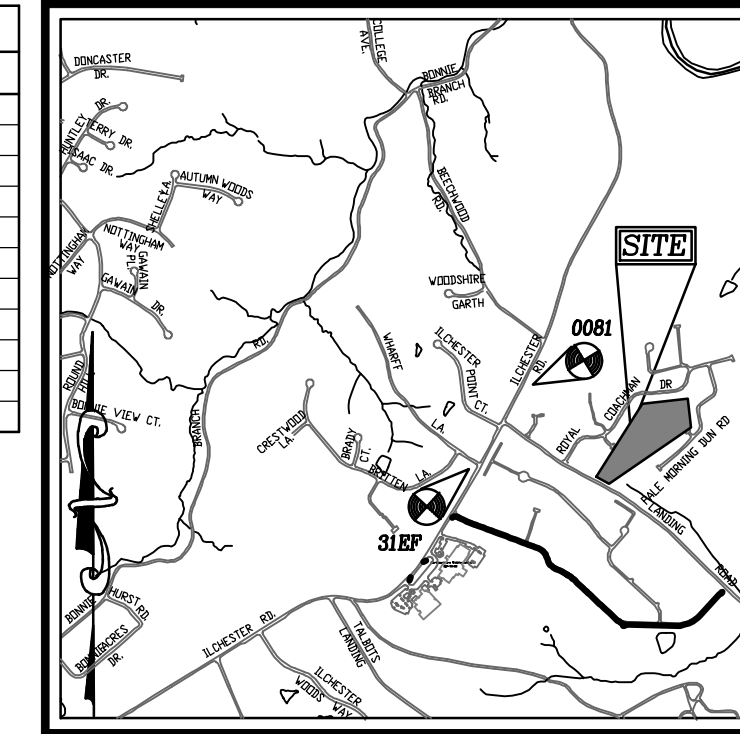

VICINITY MAP

SCALE: 1"=2,000'
ADC MAP COORDINATE: MAP 28, GRID 5E

SHEET INDEX


Table with columns: DESCRIPTION, SHEET NO. Lists sheets for COVER SHEET, PRELIMINARY LAYOUT, ROAD PROFILES AND SITE DETAILS, etc.

PARKING TABULATION:

TOTAL NUMBER OF DWELLING UNITS PROPOSED: 16
SINGLE FAMILY DETACHED (SFD) = 16 LOTS
OFF-STREET PARKING SPACES REQUIRED: 2 SPACES PER UNIT
OVERFLOW / GUEST PARKING SPACES REQUIRED: 16 x 0.5 = 8 SPACES
TOTAL OFF STREET PARKING SPACES PROVIDED: 64 SPACES

OPEN SPACE TABULATION:

IN ACCORDANCE WITH SECTION 16.121(A)(2) OF THE HOWARD COUNTY SUBDIVISION AND LAND DEVELOPMENT REGULATIONS
TOTAL OPEN SPACE PROVIDED IS 5.38 ACRES.
NON CREDITED OPEN SPACE PROVIDED: 0.053 ACRES.
CREDITED OPEN SPACE PROVIDED: 5.328 ACRES.

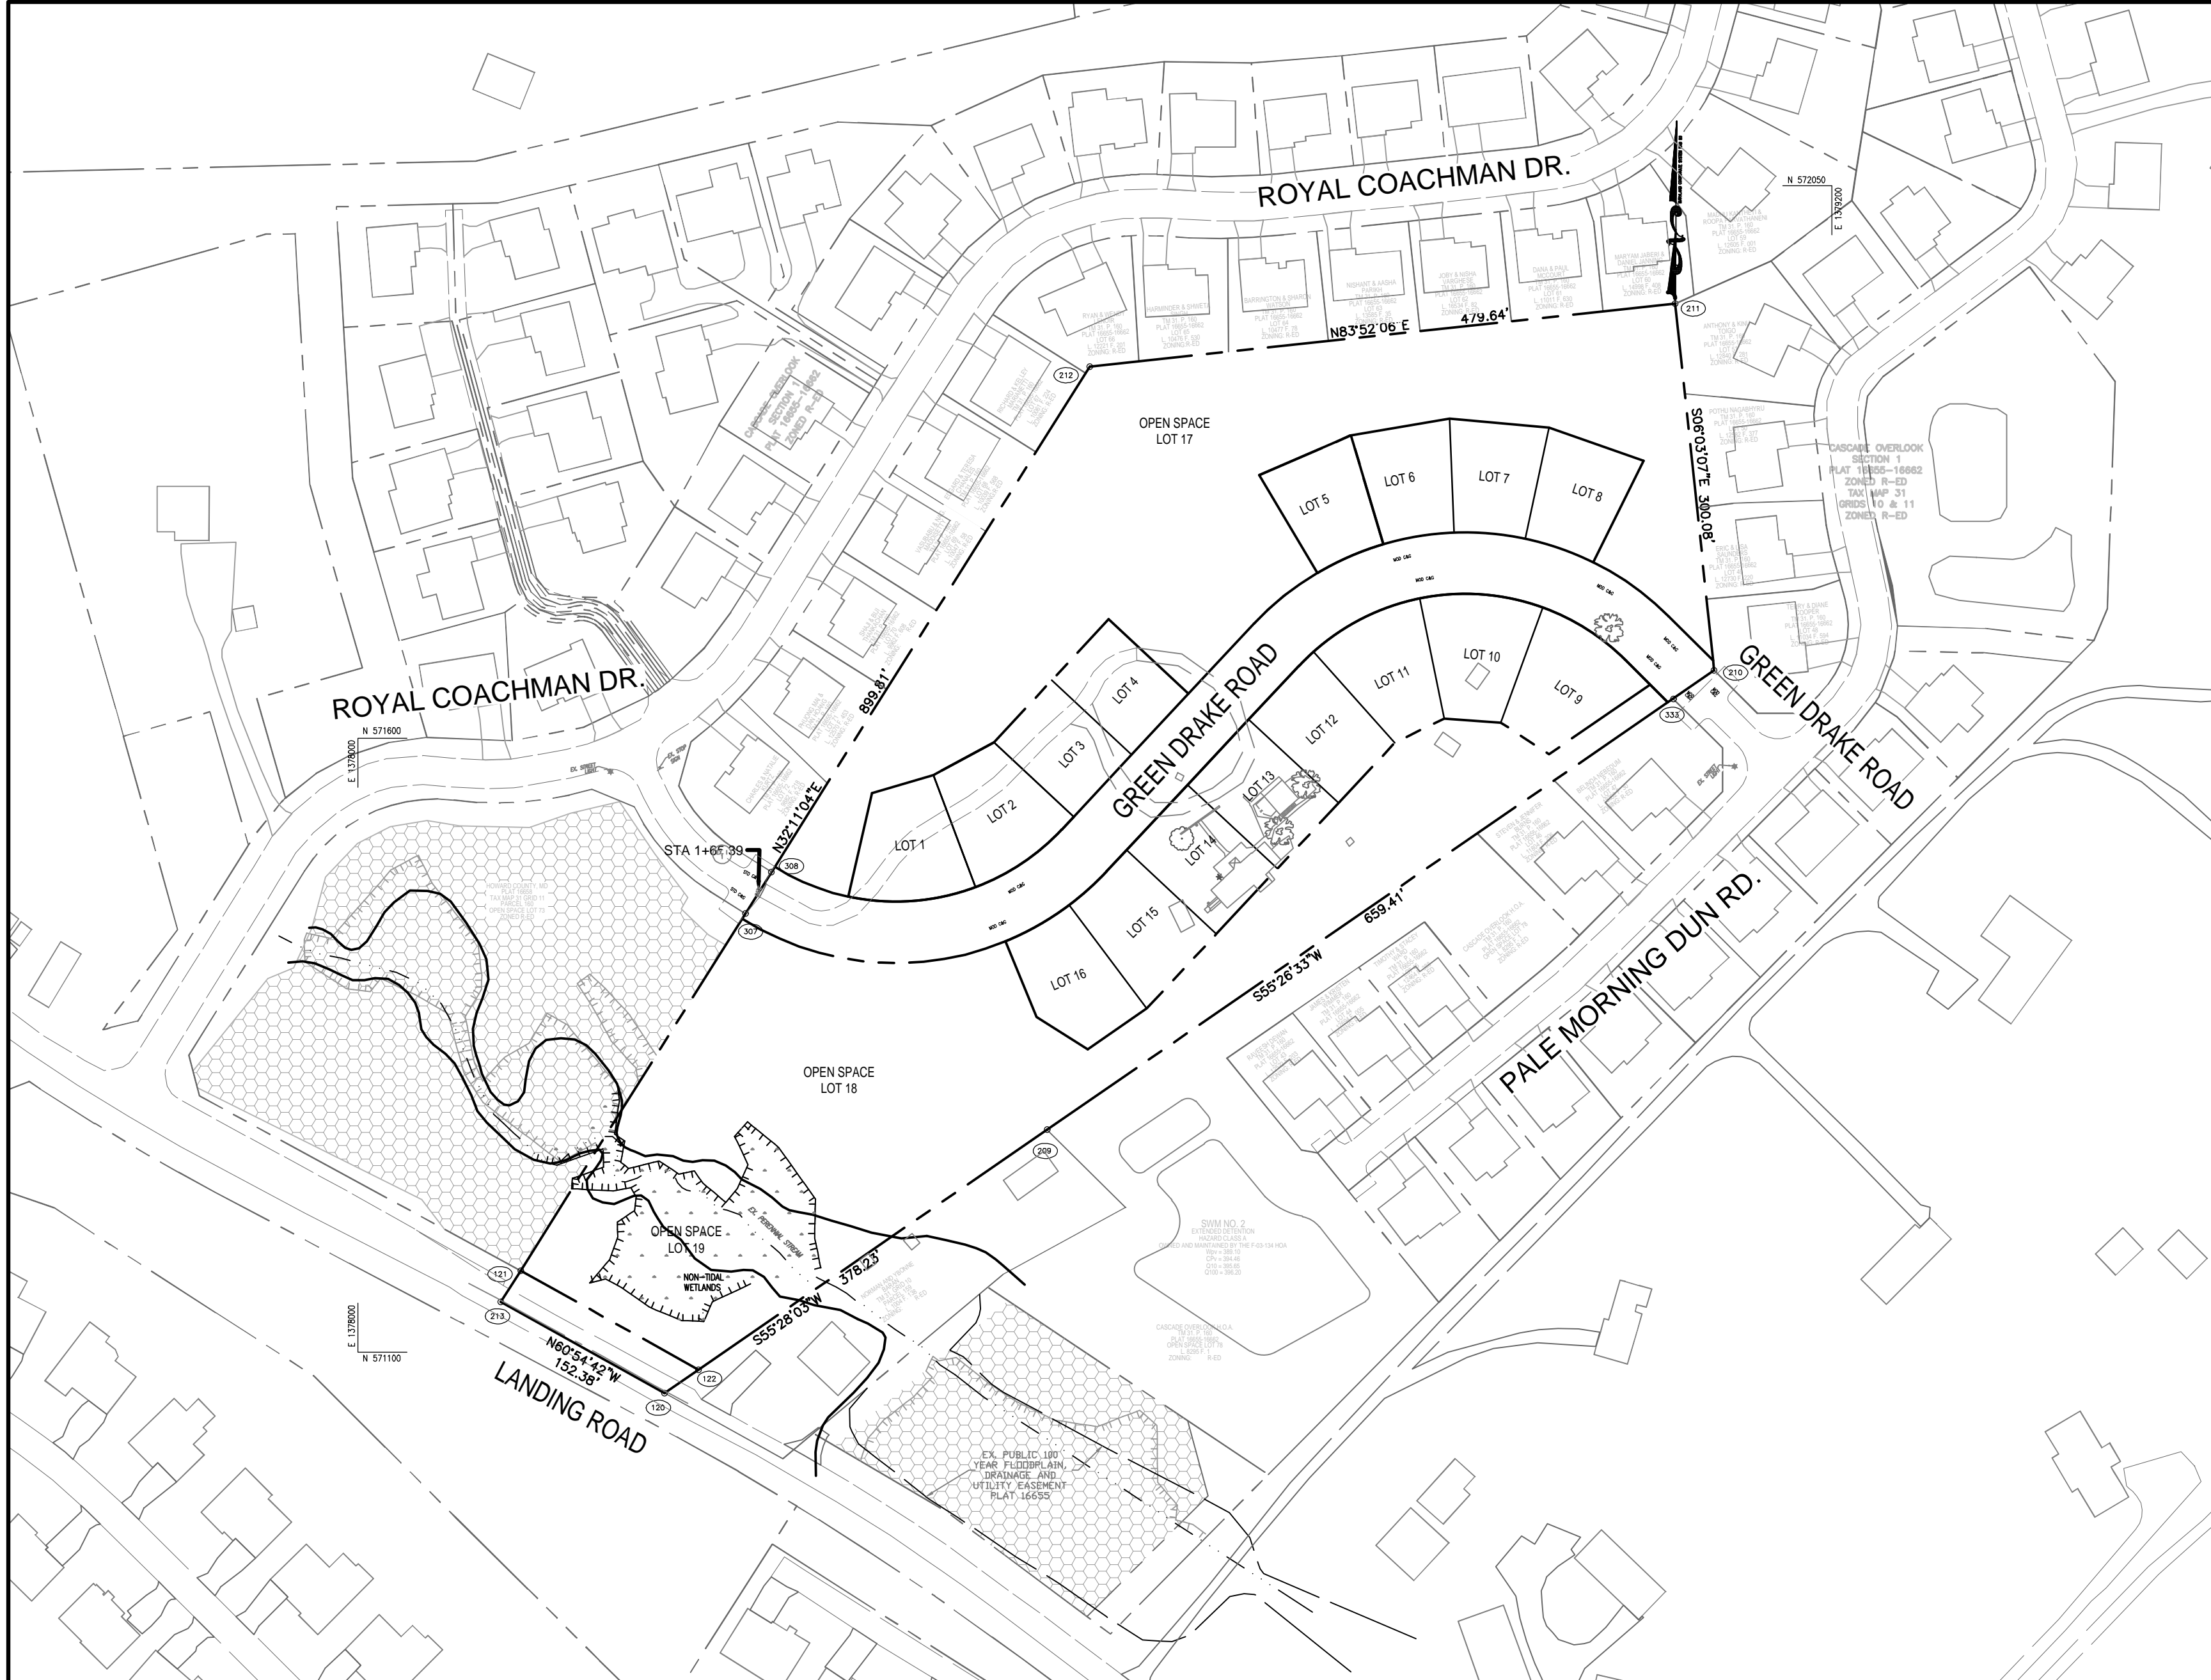

LOCATION MAP



RECREATION OPEN SPACE TABULATION:

TOTAL RECREATION OPEN SPACE REQUIRED: R-ED - SINGLE FAMILY HOMES SFD = 300 SF/UNIT X 16 UNITS = 4,800 SF
TOTAL RECREATION OPEN SPACE TO BE PROVIDED: 4,800 SF
LAND AREAS: PLAY/OT LOT EQUIPMENT (2) = 2,000 SF EA
PLUS AMENITIES: SEE BELOW
REQUIREMENT SHALL BE MET IN COMBINATION WITH THE JUNE 2012 POLICY REGARDING THE ALLOWANCE OF A MAXIMUM 50% CREDIT FOR RECREATION OPEN SPACE AMENITIES IN LIEU OF LAND AREA.

- 21. THE OFFICIAL PRE-SUBMISSION COMMUNITY MEETING WAS HELD FOR THIS PROJECT AT THE PHELPS LUCK NEIGHBORHOOD CENTER ON FEBRUARY 15, 2019 AT 6:00PM.
22. AN ENVIRONMENTAL CONCEPT PLAN (ECP-19-051) WAS APPROVED ON NOVEMBER 7, 2019.
23. IN ACCORDANCE WITH SECTION 16.121(A)(2) OF THE HOWARD COUNTY SUBDIVISION AND LAND DEVELOPMENT REGULATIONS, THE OPEN SPACE REQUIREMENTS FOR THIS R-ED PROJECT (6,000 SF MIN LOT SIZE) IS 50% OF GROSS AREA (9.085 AC. GROSS AREA X 50% = 4.54 AC.+/-).
24. IN ACCORDANCE WITH SECTION 16.121(A)(4) OF THE HOWARD COUNTY SUBDIVISION AND LAND DEVELOPMENT REGULATIONS, RECREATION OPEN SPACE FOR THIS R-ED PROJECT IS 300 SF / UNIT (16 X 300 = 4,800 SF) OF LAND AREA.

- 25. THE PROPOSED UNITS SHALL HAVE AN AUTOMATIC FIRE PROTECTION SPRINKLER SYSTEM.
26. STORMWATER MANAGEMENT FOR THE PROJECT IS PROVIDED BY THE USE OF MICRO-SCALE PRACTICES IN ACCORDANCE WITH ENVIRONMENTAL SITE DESIGN CRITERIA. MICRO-SCALE PRACTICES INCLUDE M-2 SUBMERGED GRAVEL WETLAND, M-8 MICRO-BIORETENTION, M-8 BIOWALLEYS, AND M-5 DRY WELLS. ON LOT THESE FACILITIES WILL BE PRIVATELY OWNED AND MAINTAINED.
27. THIS PLAN HAS BEEN PREPARED IN ACCORDANCE WITH SECTION 16.124 OF THE HOWARD COUNTY CODE AND THE LANDSCAPE MANUAL.

- 37. ALL SIGN POSTS USED FOR TRAFFIC CONTROL SIGNS INSTALLED IN THE COUNTY RIGHT-OF-WAY SHALL BE MOUNTED ON A 2" GALVANIZED STEEL, PERFORATED ("QUICK PUNCH"), SQUARE TUBE POST (1 1/4 GAUGE) INSERTED INTO A 2-1/2" GALVANIZED STEEL, PERFORATED, SQUARE TUBE SLEEVE (1 1/2 GAUGE) 3' LONG. THE ANCHOR SHALL NOT EXTEND MORE THAN TWO "QUICK PUNCH" HOLES ABOVE THE GROUND LEVEL.
38. TRAFFIC ENGINEERING RESERVES THE RIGHT TO POST "NO PARKING" SIGNAGE ALONG THE ENTIRE LENGTH OF GREEN DRAKE ROAD (ONE SIDE), AS NEEDED, TO INSURE EMERGENCY VEHICLE AND SNOW PLOW ACCESSIBILITY IS MAINTAINED.
39. TRAFFIC ENGINEERING RESERVES THE RIGHT TO POST "NO PARKING" SIGNAGE (BOTH SIDES) OF GREEN DRAKE ROAD AS NEEDED, TO INSURE SIGHT VISIBILITY FOR DRIVERS EXISTING THEIR DRIVEWAYS IS MAINTAINED.

TENTATIVELY APPROVED
DEPARTMENT OF PLANNING AND ZONING
HOWARD COUNTY
PLANNING DIRECTOR DATE

OWNER/DEVELOPER
JOHN NEELS
7330 GREEN DRAKE ROAD
ELKCRIDGE, MD 21075
(410) 869-0134


Table for MODERATE INCOME HOUSING UNIT (MIHU) APPLICATION EXEMPTIONS TRACKING. Columns: NO., REVISION, DATE. Rows for TOTAL NUMBER OF LOTS/UNITS PROPOSED, NUMBER OF MIHU REQUIRED, etc.

Table for REVISIONS. Columns: NO., REVISION, DATE.

PRELIMINARY EQUIVALENT SKETCH PLAN
COVER SHEET
CASCADE RIDGE
LOTS 1-16 AND OPEN SPACE LOTS 17 - 19
7330 GREEN DRAKE ROAD
ELKCRIDGE, MD 21075

VOGEL ENGINEERING
TIMMONS GROUP
3300 NORTH RIDGE ROAD, SUITE 110, ELLICOTT CITY, MD 21043
P: 410.461.7666 F: 410.461.8961 www.timmons.com


DESIGN BY: RHV
DRAWN BY: MDL/VTH
CHECKED BY: RHV
DATE: JANUARY 2020
SCALE: AS SHOWN
W.O. NO.: 42148
PROFESSIONAL CERTIFICATE
I HEREBY CERTIFY THAT THESE DOCUMENTS WERE PREPARED OR APPROVED BY ME, AND THAT I AM A FULLY LICENSED PROFESSIONAL ENGINEER UNDER THE LAWS OF THE STATE OF MARYLAND, LICENSE NO. 15353 EXPIRATION DATE: 09-27-2022

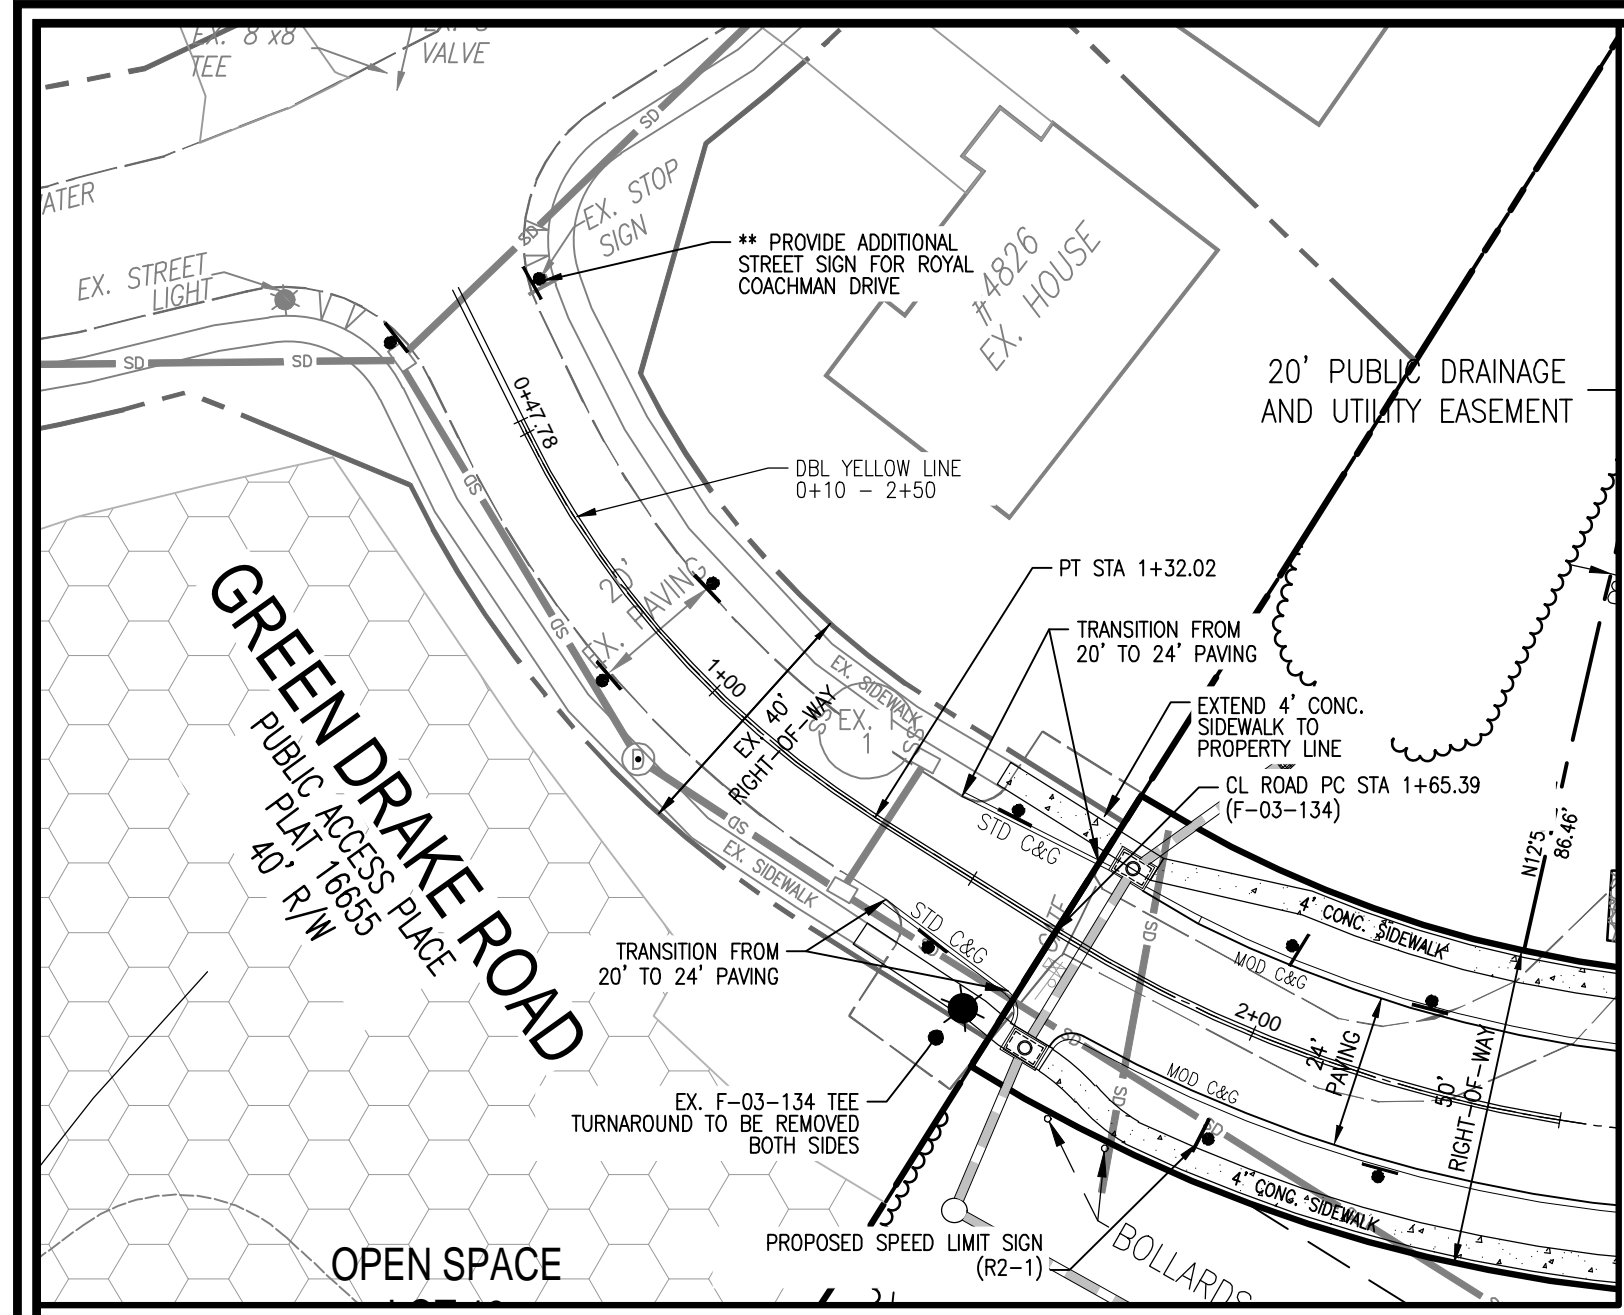


DETAIL A
SCALE: 1"=30'

CURVE TABLE

ROAD	CURVE	LENGTH	RADIUS*	DELTA ANGLE	TANGENT	CHORD DIRECTION	CHORD LENGTH
GREEN DRAKE ROAD	C1	290.00	210.00	79°07'22"	173.49	N82°35'56"E	267.50
GREEN DRAKE ROAD	C2	336.66	210.00	91°51'09"	216.90	S88°57'49"W	301.75

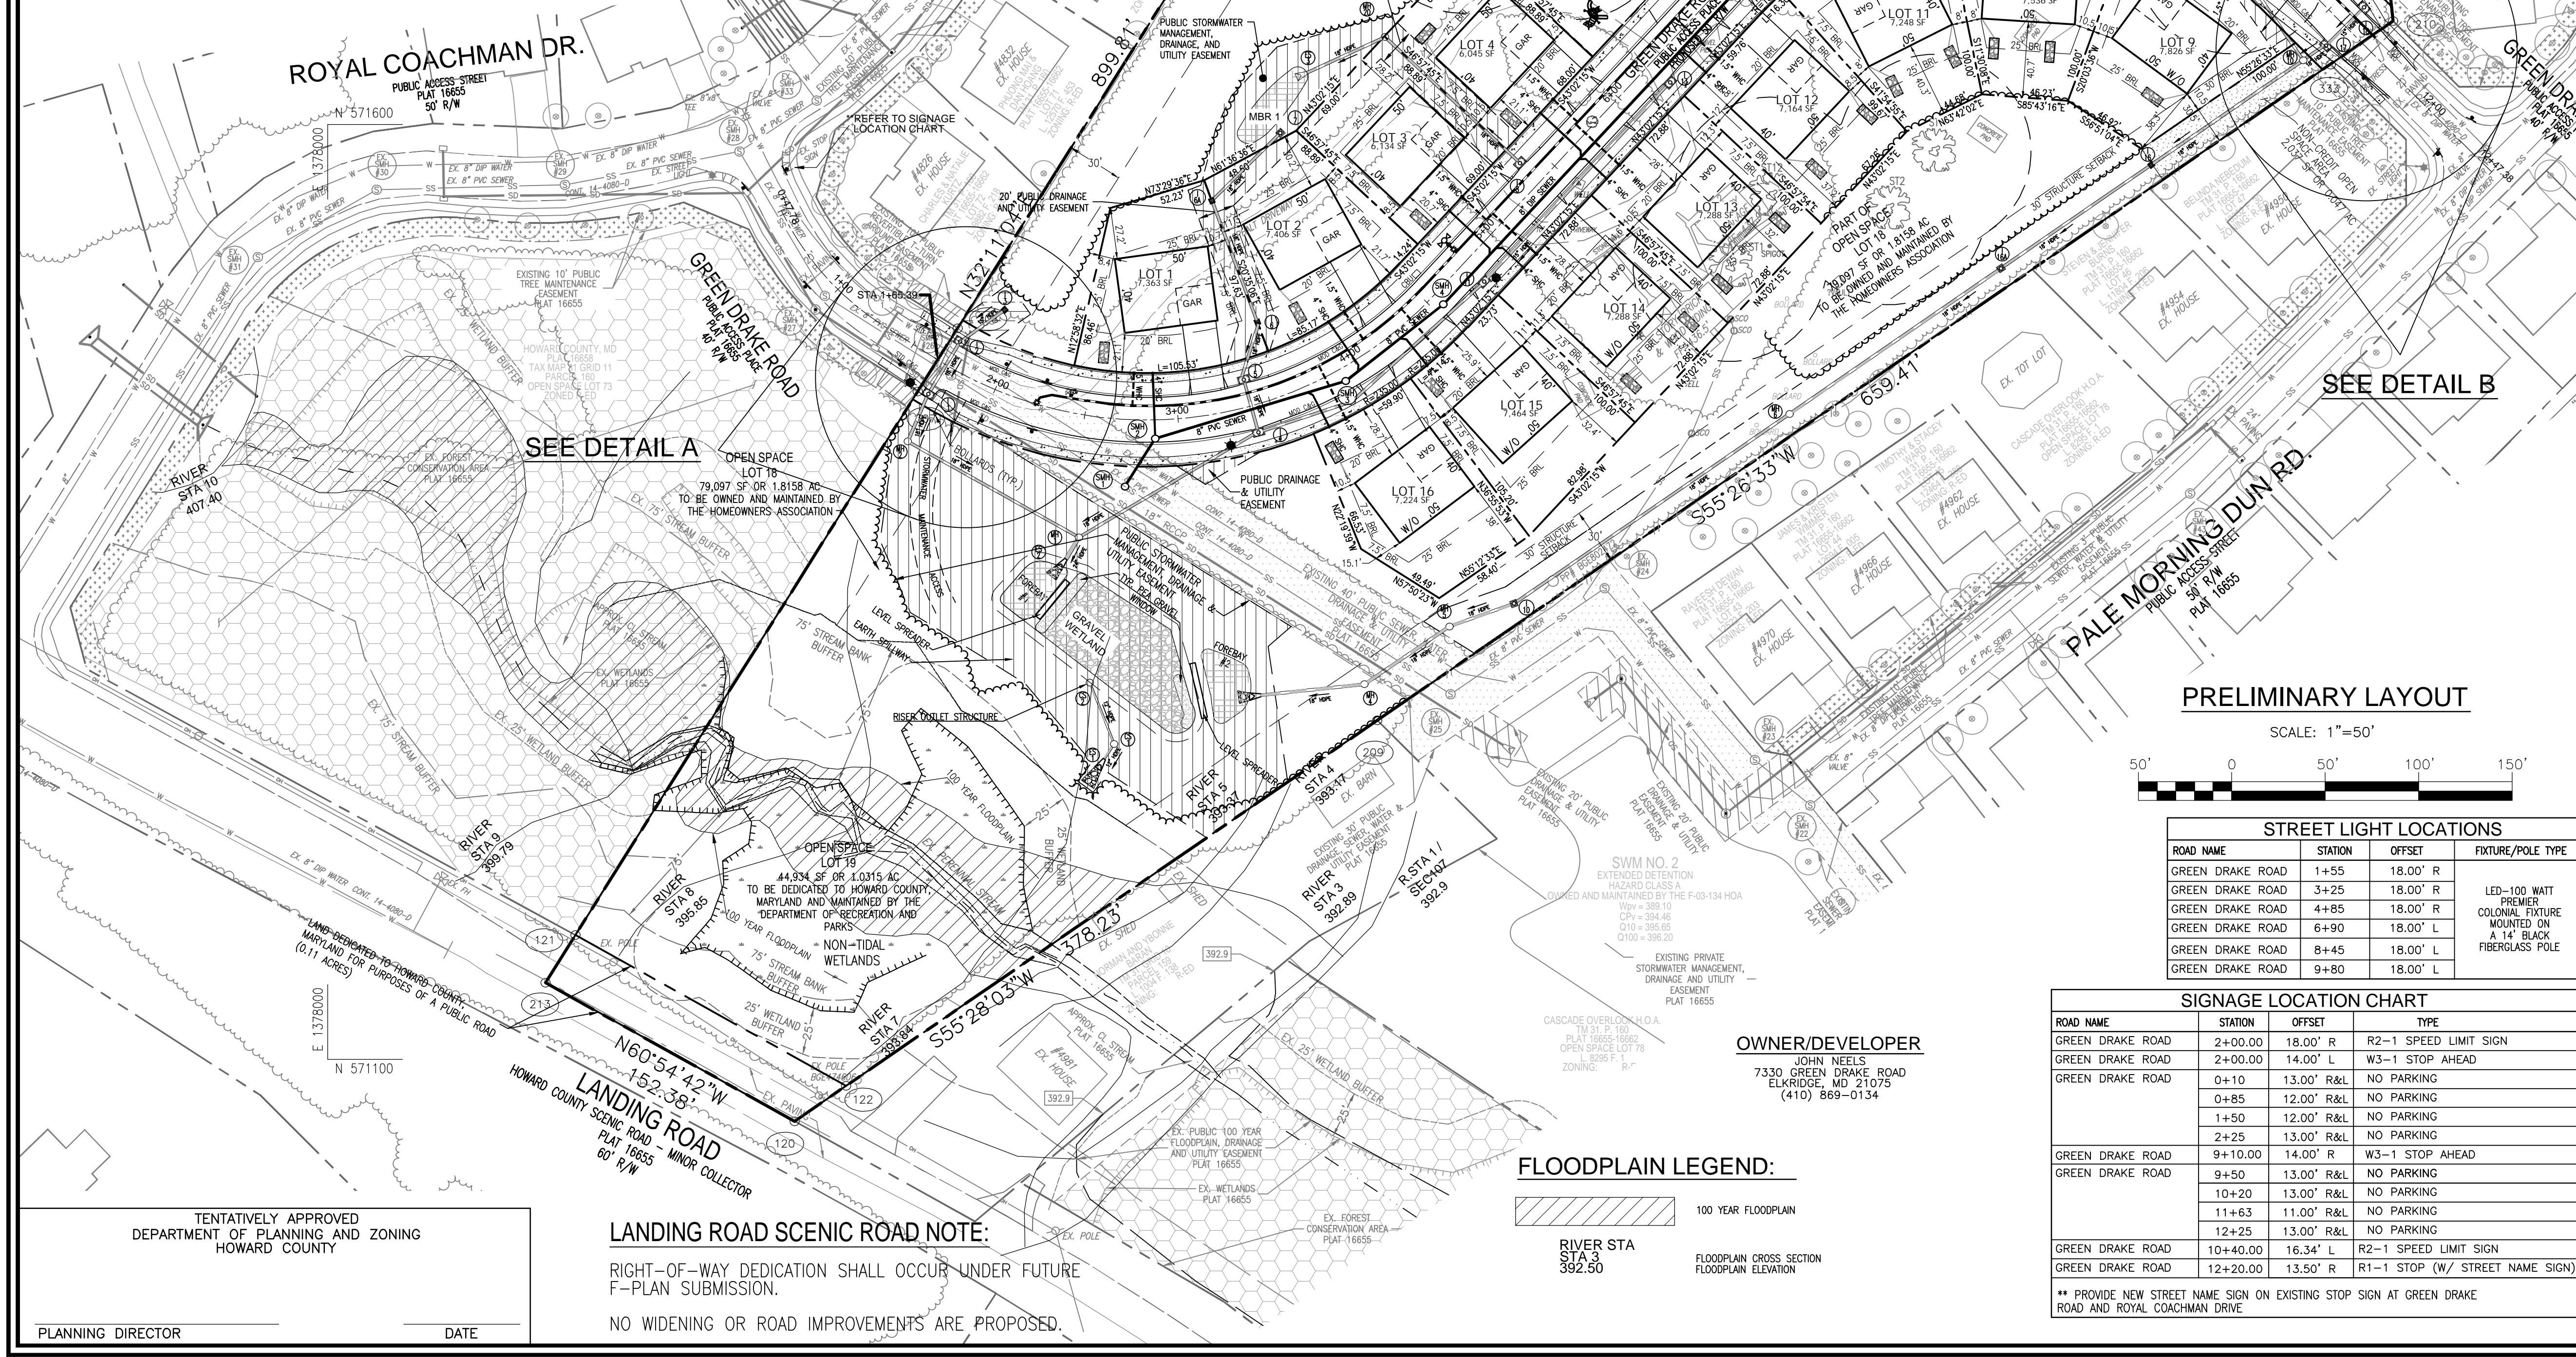

PRELIMINARY LAYOUT
SCALE: 1"=50'

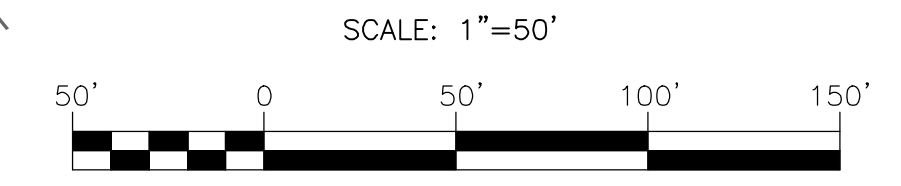

STREET LIGHT LOCATIONS


ROAD NAME	STATION	OFFSET	FIXTURE/POLE TYPE
GREEN DRAKE ROAD	1+55	18.00' R	LED-100 WATT PREMIER
GREEN DRAKE ROAD	3+25	18.00' R	LED-100 WATT PREMIER
GREEN DRAKE ROAD	4+85	18.00' R	LED-100 WATT PREMIER
GREEN DRAKE ROAD	6+90	18.00' L	LED-100 WATT PREMIER
GREEN DRAKE ROAD	8+45	18.00' L	LED-100 WATT PREMIER
GREEN DRAKE ROAD	9+80	18.00' L	LED-100 WATT PREMIER

SIGNAGE LOCATION CHART

ROAD NAME	STATION	OFFSET	TYPE
GREEN DRAKE ROAD	2+00.00	18.00' R	R2-1 SPEED LIMIT SIGN
GREEN DRAKE ROAD	2+00.00	14.00' L	W3-1 STOP AHEAD
GREEN DRAKE ROAD	0+10	13.00' R&L	NO PARKING
GREEN DRAKE ROAD	0+85	12.00' R&L	NO PARKING
GREEN DRAKE ROAD	1+50	12.00' R&L	NO PARKING
GREEN DRAKE ROAD	2+25	13.00' R&L	NO PARKING
GREEN DRAKE ROAD	9+10.00	14.00' R	W3-1 STOP AHEAD
GREEN DRAKE ROAD	9+50	13.00' R&L	NO PARKING
GREEN DRAKE ROAD	10+20	13.00' R&L	NO PARKING
GREEN DRAKE ROAD	11+63	11.00' R&L	NO PARKING
GREEN DRAKE ROAD	12+25	13.00' R&L	NO PARKING
GREEN DRAKE ROAD	10+40.00	16.34' L	R2-1 SPEED LIMIT SIGN
GREEN DRAKE ROAD	12+20.00	13.50' R	R1-1 STOP (W/ STREET NAME SIGN)

** PROVIDE NEW STREET NAME SIGN ON EXISTING STOP SIGN AT GREEN DRAKE ROAD AND ROYAL COACHMAN DRIVE

- LEGEND:**
- PROPERTY LINE
 - RIGHT-OF-WAY LINE
 - ADJACENT PROPERTY LINE
 - EXISTING PAVING
 - EXISTING UTILITY POLE
 - EXISTING SANITARY MANHOLE
 - EXISTING SANITARY LINE
 - EXISTING FIRE HYDRANT
 - EXISTING WATER LINE
 - EXISTING 10' CONTOUR
 - EXISTING 2' CONTOUR
 - SOILS
 - EXISTING TREELINE
 - CENTERLINE OF EXISTING STREAM
 - EXISTING SPECIMEN TREE
 - EXISTING WETLANDS
 - EXISTING WETLAND BUFFER
 - EX. PUBLIC 100-YEAR FLOOD PLAN
 - EXISTING FOREST CONSERVATION EASEMENT (PLAT 16655)
 - PROPOSED STORMDRAIN
 - PROPOSED SIDEWALK
 - PROPOSED TREELINE
 - PROPOSED CURB
 - PROPOSED 10' CONTOUR
 - PROPOSED 2' CONTOUR
 - PROPOSED PRIVATE DRAINAGE & UTILITY EASEMENT
 - PROPOSED PUBLIC DRAINAGE & UTILITY EASEMENT
 - PROPOSED MICRO-BIORETENTION FACILITY
 - PROPOSED STORMWATER DRYWELL
 - PROPOSED 8" PVC PUBLIC SANITARY SEWER
 - PROPOSED 8" DIP PUBLIC WATER
 - EXISTING PUBLIC SEWER, WATER DRAINAGE & UTILITY EASEMENT (PLAT 16655)
 - PROPOSED STREET LIGHT
 - PROPOSED STREET SIGN

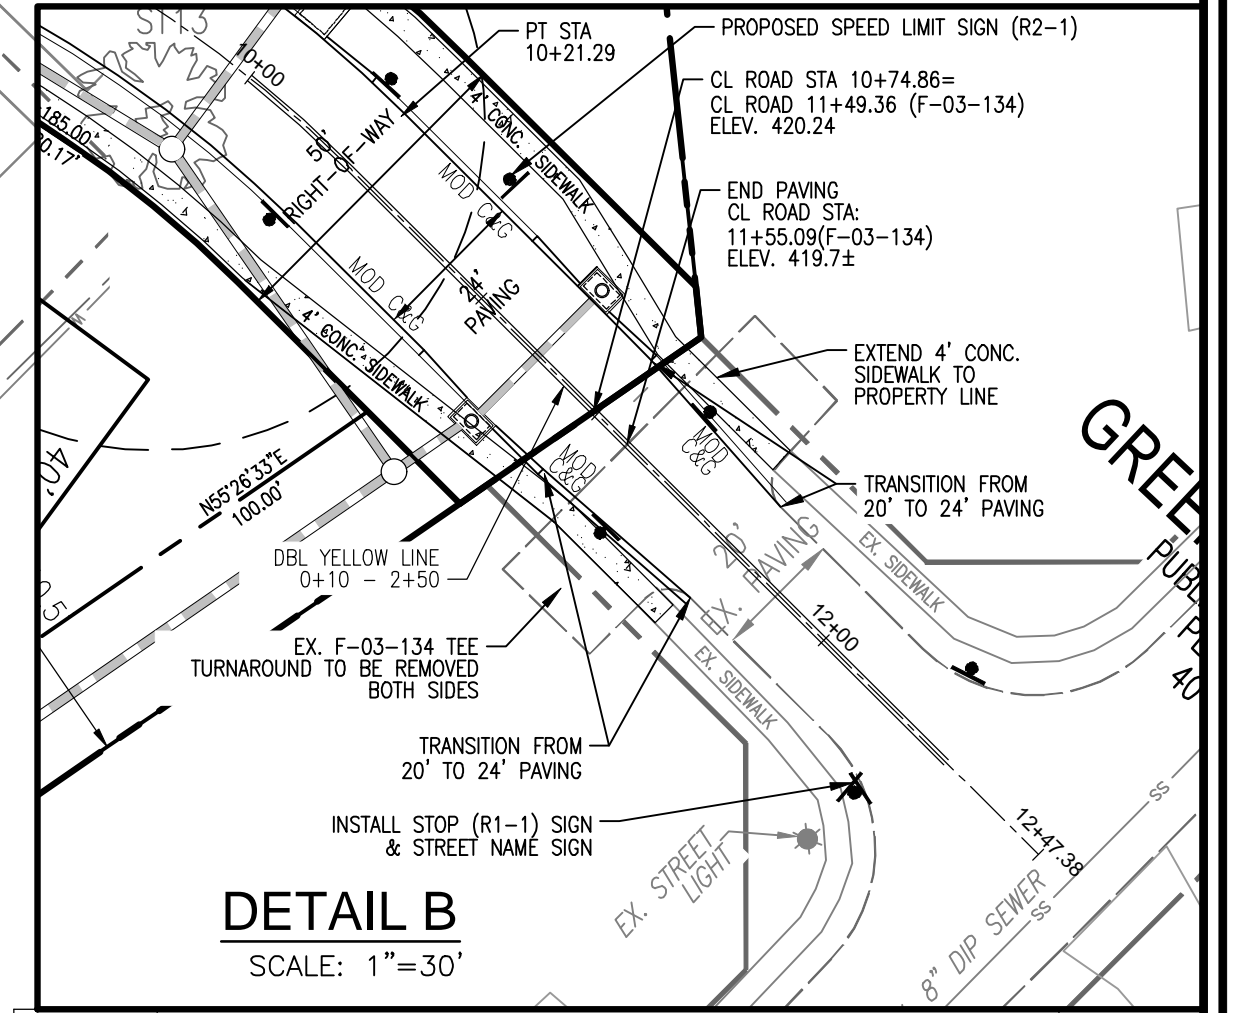

DETAIL B
SCALE: 1"=30'

NO.	REVISION	DATE


PRELIMINARY EQUIVALENT SKETCH PLAN

PRELIMINARY LAYOUT
CASCADE RIDGE
LOTS 1-16 AND OPEN SPACE LOTS 17 - 19
7330 GREEN DRAKE ROAD
ELK RIDGE, MD 21075

PARCEL: 474
TAX MAP: 31 GRID: 11
1ST ELECTION DISTRICT

ZONED: R-ED
L 362 / F. 260
HOWARD COUNTY, MARYLAND


VOGEL ENGINEERING
TIMMONS GROUP
3300 NORTH RIDGE ROAD, SUITE 110, ELLICOTT CITY, MD 21043
P: 410.461.7666 F: 410.461.8961 www.timmons.com

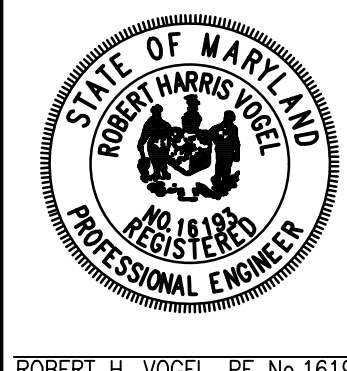





DESIGN BY: RHV
DRAWN BY: MDL/VETG
CHECKED BY: RHV
DATE: JANUARY 2020
SCALE: AS SHOWN
W.O. NO.: 42148

I HEREBY CERTIFY THAT THESE DOCUMENTS WERE PREPARED OR APPROVED BY ME, AND THAT I AM A FULLY LICENSED PROFESSIONAL ENGINEER UNDER THE LAWS OF THE STATE OF MARYLAND, LICENSE NO. 16193, EXPIRATION DATE: 09-27-2022

TYPICAL CENTRAL MAIL DELIVERY BOX (CBU)
OR APPROVED EQUAL

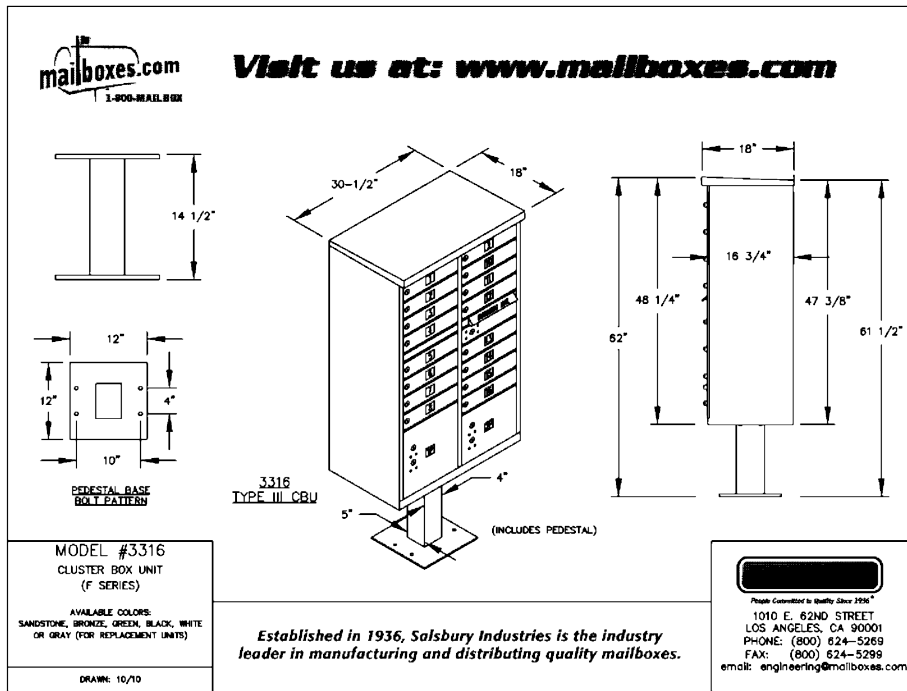


ONE 8 UNIT BOX NEAR LOT 2 TO SERVE LOTS 1-4, AND 15-17
ONE 12 UNIT BOX NEAR LOT 13 TO SERVE LOTS 5-10, AND 11-14

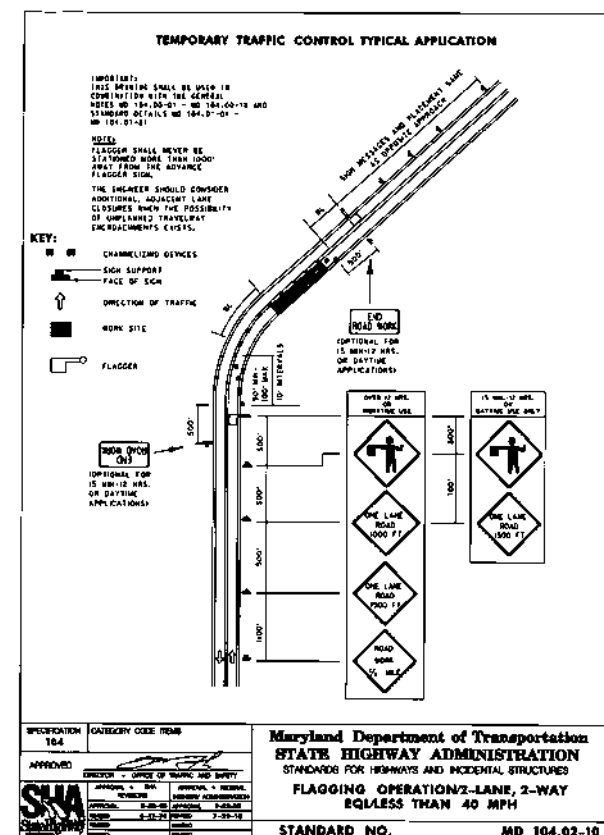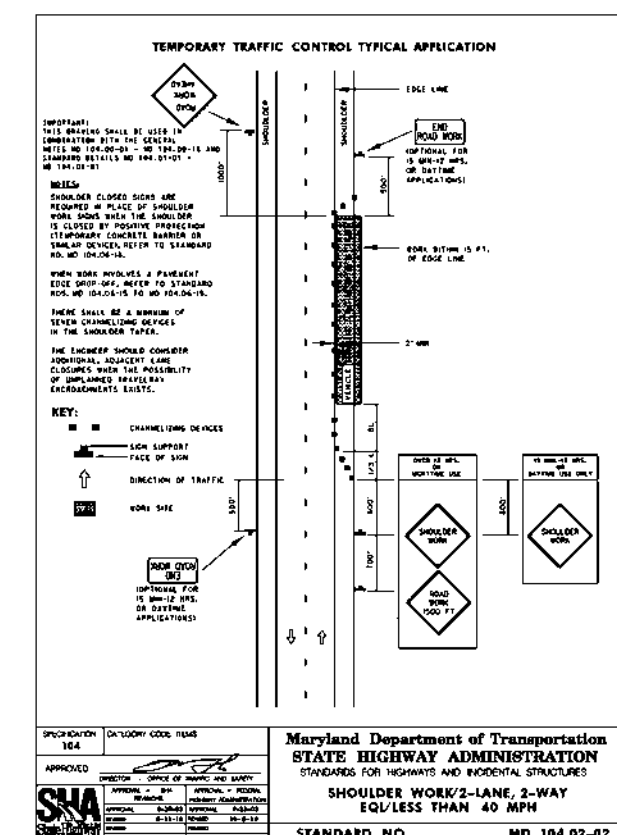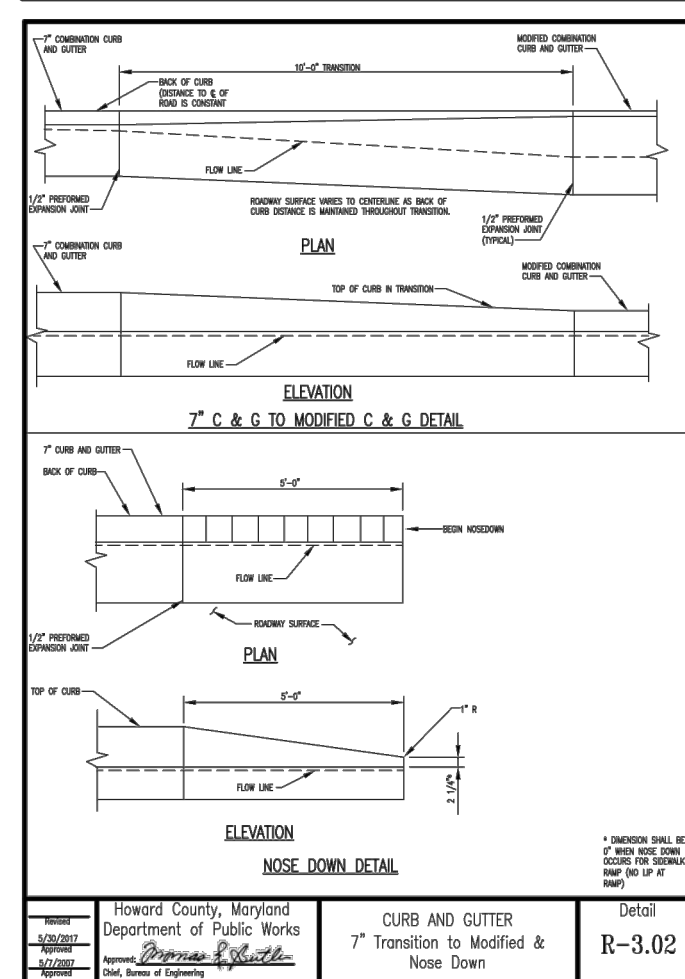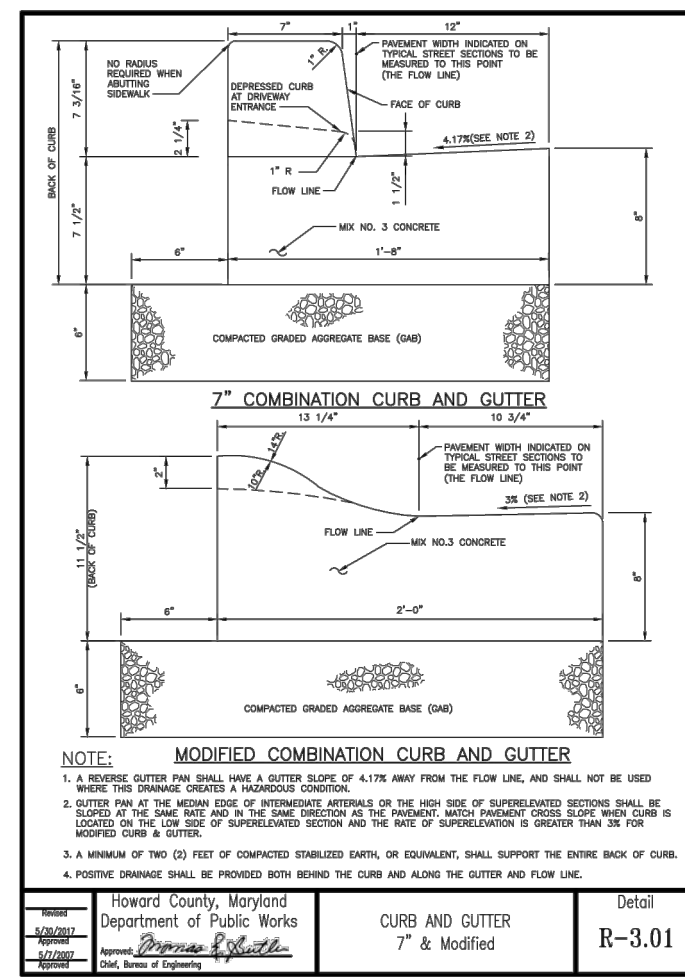

**ROYAL COACHMAN DRIVE & PALE MORNING ROAD
TYPICAL WORK ZONE
TRAFFIC CONTROL DETAILS**

ALL WORK WITHIN THE ROYAL COACHMAN DRIVE AND/OR PALE MORNING ROAD PUBLIC RIGHT-OF-WAY SHALL BE IN ACCORDANCE WITH THE STANDARD MARYLAND STATE HIGHWAY ADMINISTRATION DETAILS: MD 104.02-02 & MD 104.02-10 OR AS DIRECTED BY THE HOWARD COUNTY - TRAFFIC ENGINEERING DIVISION.

TENTATIVELY APPROVED
DEPARTMENT OF PLANNING AND ZONING
HOWARD COUNTY

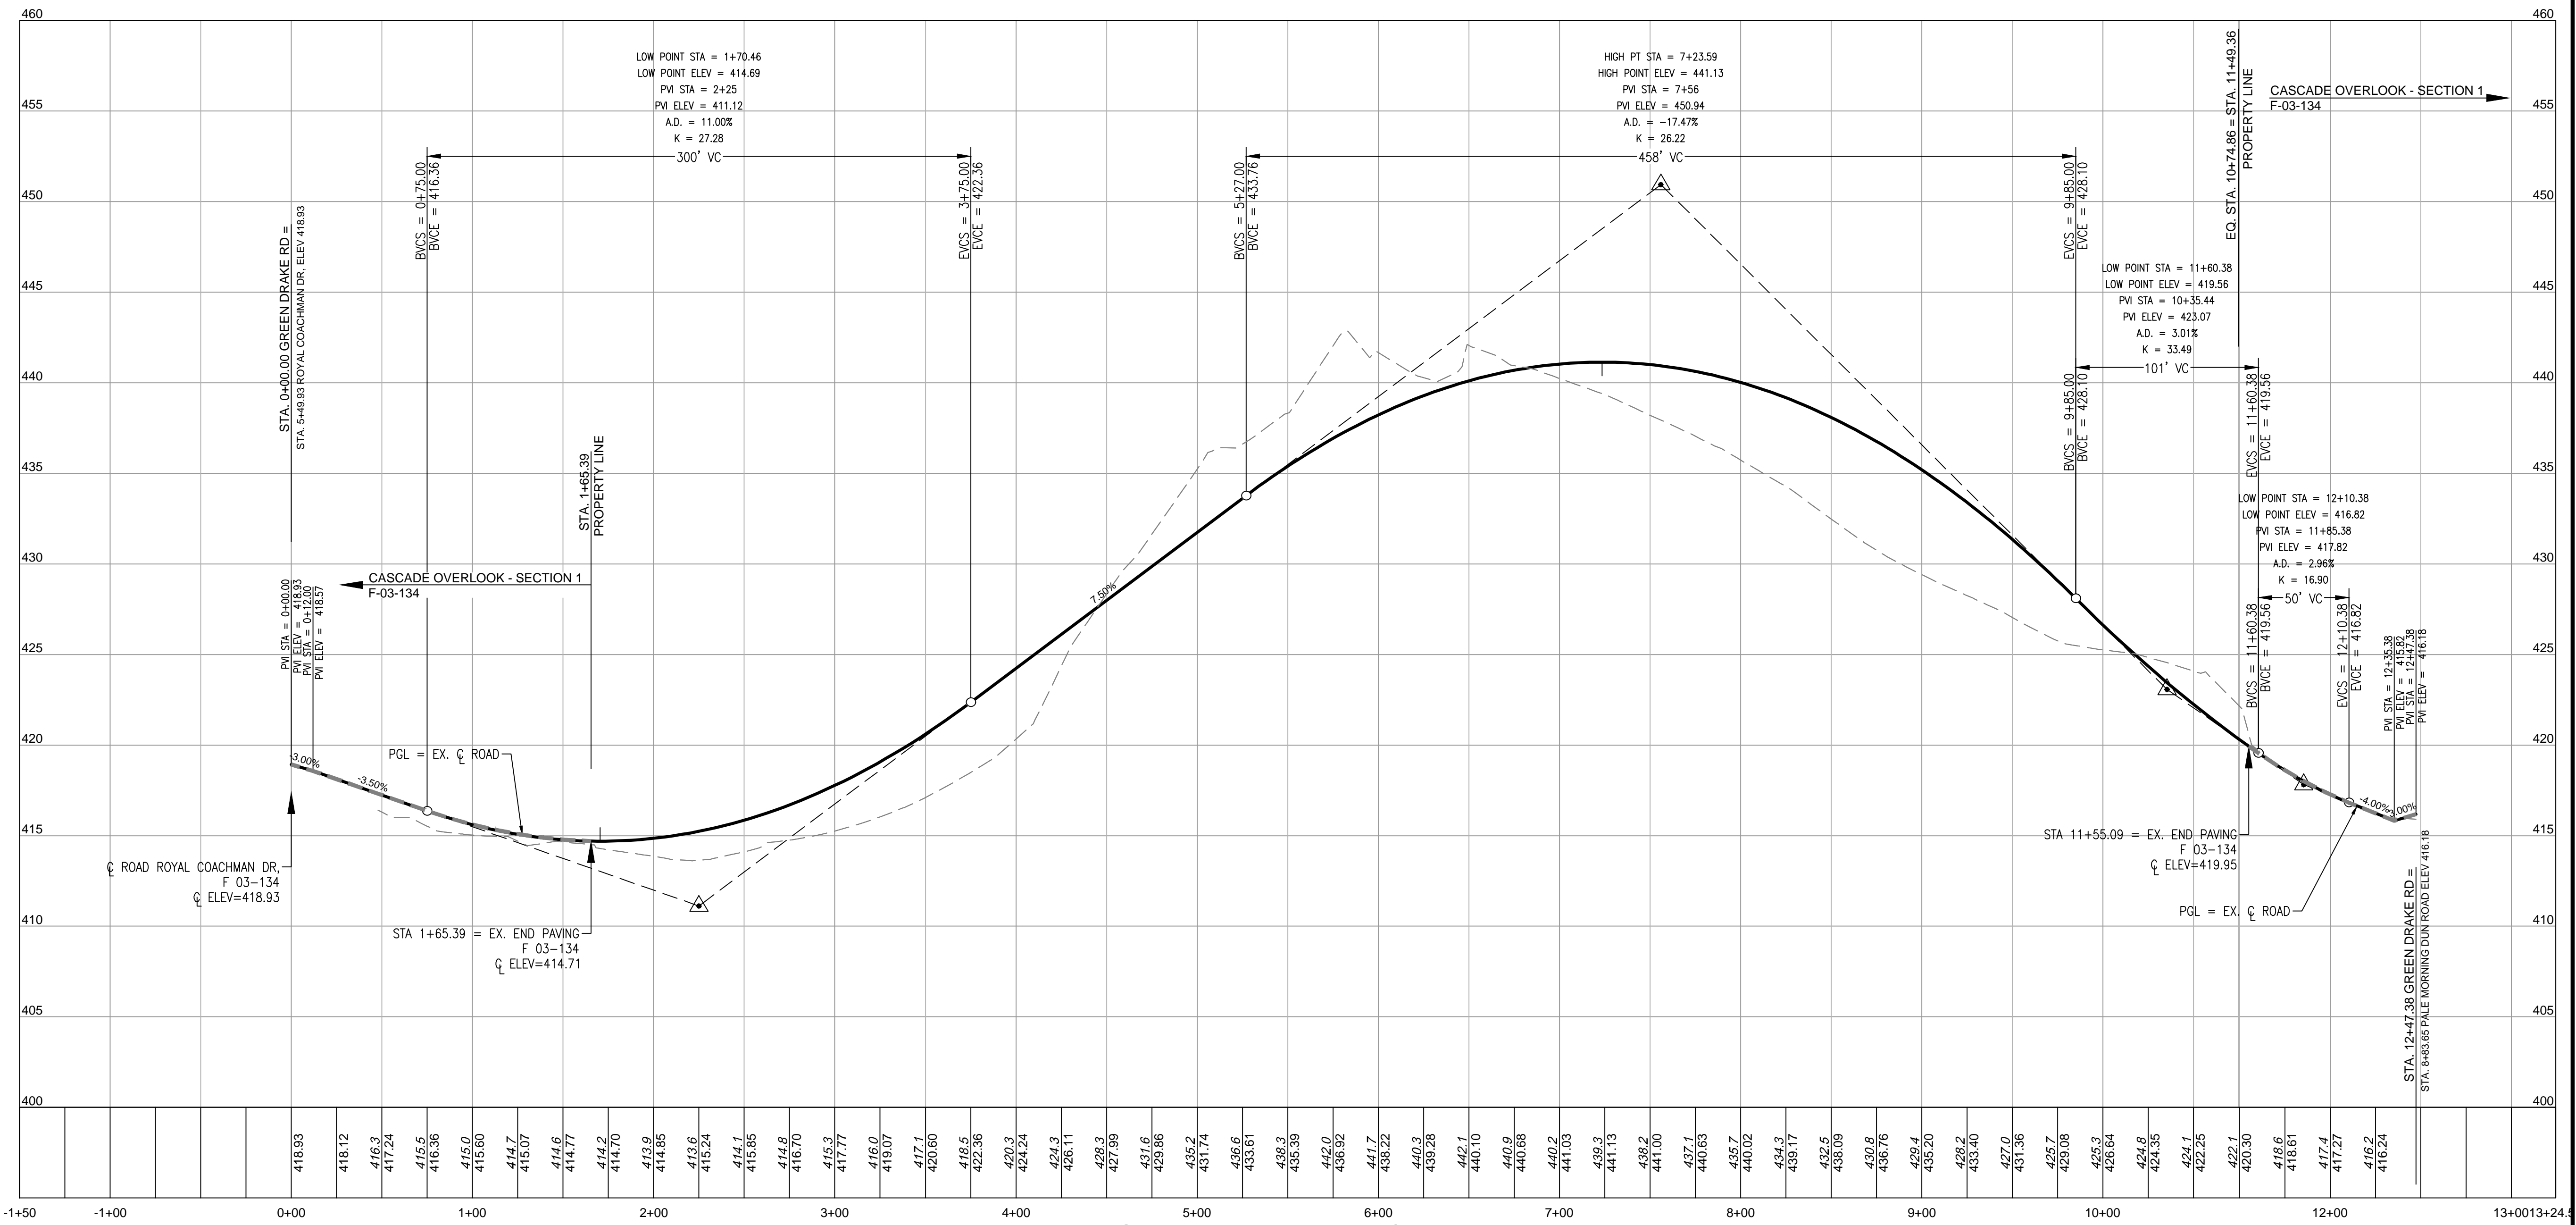


GREEN DRAKE RD PROFILE

HORIZ SCALE: 1"=50'

VERT SCALE: 1"=5'


ACCESS STREET / ACCESS PLACE EXTENSIONS
DESIGN SPEED = 25MPH

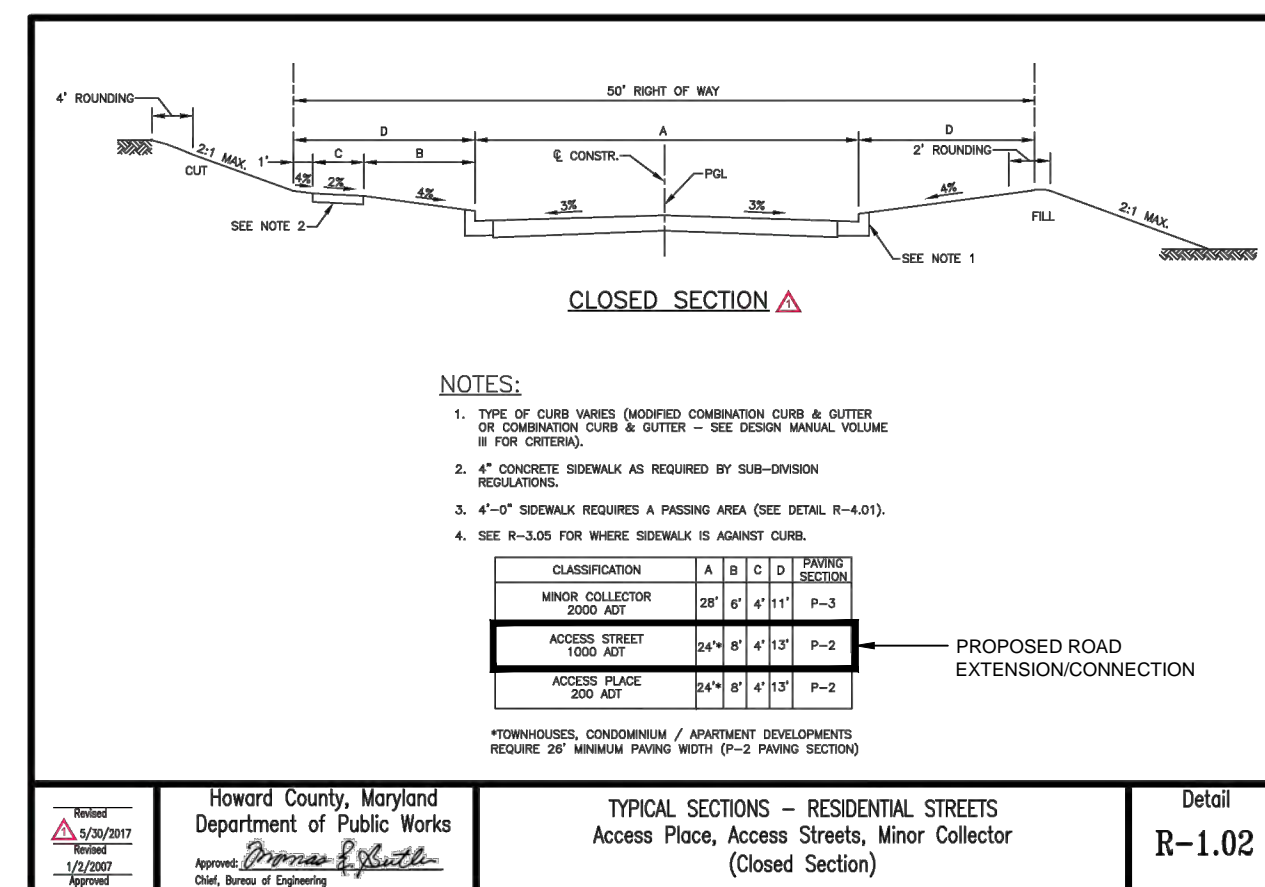

Howards County, Maryland
Department of Public Works
Detail
R-1.02

SECTION NUMBER	ROAD AND STREET CLASSIFICATION	CALIFORNIA MIXING BOWL (CMB)	MIN. SUPERPAVE ASPHALT MIX WITH CONVEYANT SAND	MIN. SUPERPAVE ASPHALT MIX WITH CONVEYANT SAND	MIN. SUPERPAVE ASPHALT MIX WITH CONVEYANT SAND
P-1	PARALLEL DRIVE	SUPERPAVE ASPHALT MIX WITH CONVEYANT SAND 9.5 MM PG 64-235, LEVEL 1 (2.5%)	1.5	1.5	1.5
P-2	PARALLEL DRIVE	SUPERPAVE ASPHALT MIX WITH CONVEYANT SAND 9.5 MM PG 64-235, LEVEL 1 (2.5%)	1.5	1.5	1.5
P-3	MINOR COLLECTOR	SUPERPAVE ASPHALT MIX WITH CONVEYANT SAND 9.5 MM PG 64-235, LEVEL 1 (2.5%)	1.5	1.5	1.5
P-4	ACCESS STREET	SUPERPAVE ASPHALT MIX WITH CONVEYANT SAND 9.5 MM PG 64-235, LEVEL 1 (2.5%)	1.5	1.5	1.5

Howards County, Maryland
Department of Public Works
Detail
R-2.01

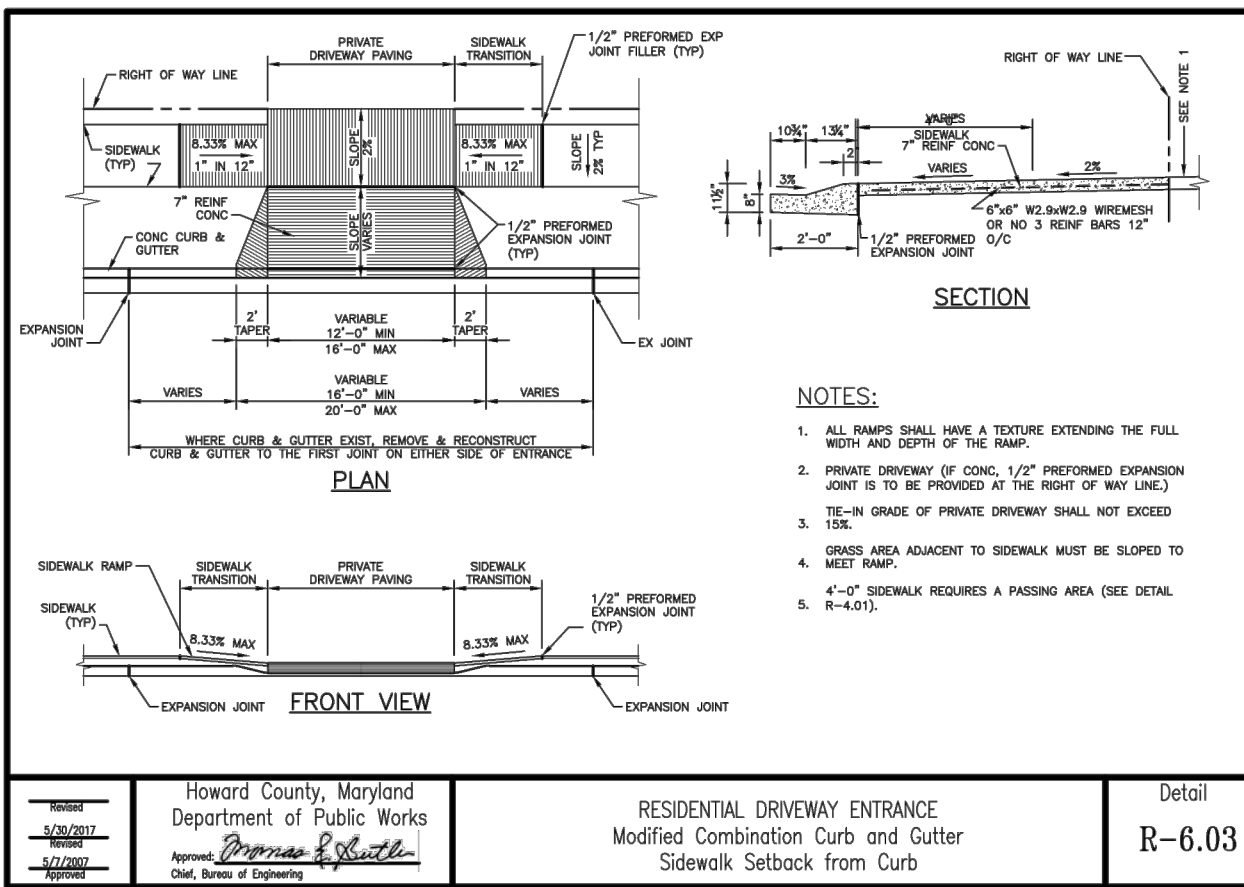

Howards County, Maryland
Department of Public Works
Detail
R-6.03

OWNER/DEVELOPER
JOHN NEELS
7330 GREEN DRAKE ROAD
ELK RIDGE, MD 21075
(410) 869-0134

NO.	REVISION	DATE

PRELIMINARY EQUIVALENT SKETCH PLAN
PRELIMINARY ROAD PROFILE & DETAILS
CASCAD RIDGE
LOTS 1-16 AND OPEN SPACE LOTS 17 - 19
7330 GREEN DRAKE ROAD
ELK RIDGE, MD 21075

PARCEL: 474
TAX MAP: 31 GRID: 11
1ST ELECTION DISTRICT

ZONED: R-ED
L 362 / F. 260
HOWARD COUNTY, MARYLAND

VOGEL ENGINEERING
TIMMONS GROUP
3300 NORTH RIDGE ROAD, SUITE 110, ELLICOTT CITY, MD 21043
P: 410.461.7666 F: 410.461.8961 www.timmons.com

PROFESSIONAL CERTIFICATE
I HEREBY CERTIFY THAT THESE DOCUMENTS WERE PREPARED OR APPROVED BY ME, AND THAT I AM A DAILY LICENSED PROFESSIONAL ENGINEER UNDER THE LAWS OF THE STATE OF MARYLAND, LICENSE NO. 16193, EXPIRATION DATE: 09-27-2022

DESIGN BY: RHV
DRAWN BY: MDL/VET
CHECKED BY: RHV
DATE: JANUARY 2020
SCALE: AS SHOWN
W.O. NO.: 42148

3 SHEET OF 10

HSCD NOTES:

APPROVAL OF THIS PRELIMINARY EQUIVALENT SKETCH PLAN (SP) BY THE HOWARD SOIL CONSERVATION DISTRICT DOES NOT GRANT APPROVAL OF THE PROPOSED SEDIMENT CONTROL SCHEME.

1. THE FINAL PLAN SHALL INCLUDE A SEQUENCE OF CONSTRUCTION WHICH SHALL DETAIL SEDIMENT & EROSION CONTROLS AND PHASING.
2. THE PROJECT SHALL ADDRESS ANY TEMPORARY STORMWATER MANAGEMENT REQUIREMENTS.
3. THE FINAL PLAN SUBMISSION SHALL PROVIDE A DRAINAGE AREA MAP SPECIFIC TO CHOSEN SEDIMENT CONTROLS.
4. THE FINAL PLAN SUBMISSION SHALL PROVIDE COMPUTATIONS TO VERIFY VELOCITIES ALONG DIKES, SWALES AND AT DIKES OUTLET LOCATIONS.

NOTES:

1. APPROVAL OF THIS PRELIMINARY GRADING AND SOIL EROSION AND SEDIMENT CONTROL PLAN DOES NOT CONSTITUTE AN APPROVAL OF ANY SUBSEQUENT AND ASSOCIATED BUILDING AND/OR GRADING PERMIT.
2. THERE ARE NO ENVIRONMENTAL FEATURES: FLOODPLAIN, WETLANDS, STREAMS, STEEP SLOPES OR FOREST THAT EXISTS WITHIN THE PROPOSED LIMIT OF DISTURBANCE.

LEGEND:

- PROPERTY LINE
- - - RIGHT-OF-WAY LINE
- - - ADJACENT PROPERTY LINE
- - - EXISTING PAVING
- - - EXISTING UTILITY POLE
- EXISTING SANITARY MANHOLE
- EXISTING SANITARY LINE
- EXISTING FIRE HYDRANT
- EXISTING WATER LINE
- - - EXISTING 10' CONTOUR
- - - EXISTING 2' CONTOUR
- SOILS
- EXISTING TREELINE
- CENTERLINE OF EXISTING STREAM
- EXISTING WETLANDS
- EXISTING WETLAND BUFFER
- EX. PUBLIC 100-YEAR FLOOD PLAN
- EXISTING FOREST CONSERVATION EASEMENT (PLAT 16655)
- PROPOSED STORMDRAIN
- PROPOSED SIDEWALK
- PROPOSED TREELINE
- PROPOSED CURB
- PROPOSED 10' CONTOUR
- PROPOSED 2' CONTOUR
- LOD — LOD LIMIT OF DISTURBANCE
- STABILIZED CONSTRUCTION ENTRANCE W/ MOUNTABLE BERM
- RIPRAP PROTECTION
- BAFFLE
- RPS REMOVABLE PUMPING STATION
- SSF SUPER SILT FENCE
- SF SILT FENCE
- EARTHDIKE
- HIGHLY ERODIBLE SOILS
- EXISTING PUBLIC SEWER, WATER DRAINAGE & UTILITY EASEMENT (PLAT 16655)
- MODERATE SLOPES (15%-24.9%)
- STEEP SLOPES (25%)
- DRAINAGE DWIDE

NOTE:
 - SILT FENCE IS TO BE REPLACED WITH SUPER SILT FENCE AT THE DIRECTION OF THE SEDIMENT CONTROL INSPECTOR.
 - SILT FENCE SHALL BE CURLED UPHILL NO MORE THAN 35 FEET APART
 - DOUBLE ROWS OF SUPER SILT FENCE SHALL BE INSTALLED AT THE DIRECTION OF THE SEDIMENT CONTROL INSPECTOR.

NOTE:
 EITHER PERMANENT OR TEMPORARY STABILIZATION IS TO BE APPLIED AT THE DIRECTION OF THE SEDIMENT CONTROL INSPECTOR REGARDLESS OF DAYS/DATES IN THE STANDARD SEDIMENT CONTROL NOTES AND/OR SEEDING SPECIFICATIONS.

NO.	REVISION	DATE

PRELIMINARY EQUIVALENT SKETCH PLAN
 PHASE 1 - SOILS MAP, PRELIMINARY GRADING AND SOIL EROSION & SEDIMENT CONTROL PLAN
CASCADE RIDGE
 LOTS 1-16 AND OPEN SPACE LOTS 17 - 19
 7330 GREEN DRAKE ROAD
 ELKRIE, MD 21075

VOGEL ENGINEERING
 +
TIMMONS GROUP
 3300 NORTH RIDGE ROAD, SUITE 110, ELLIOTT CITY, MD 21043
 P: 410.461.7666 F: 410.461.8961 www.timmons.com

DESIGN BY: RHV
 DRAWN BY: MDL VETG
 CHECKED BY: RHV
 DATE: JANUARY 2020
 SCALE: AS SHOWN
 W.O. NO.: 42148

PROFESSIONAL CERTIFICATE
 I HEREBY CERTIFY THAT THESE DOCUMENTS WERE PREPARED OR APPROVED BY ME, AND THAT I AM A FULLY LICENSED PROFESSIONAL ENGINEER UNDER THE LAWS OF THE STATE OF MARYLAND, LICENSE NO. 16193, EXPIRATION DATE: 09-27-2022


ROBERT H. VOGEL, PE No.16193

MAPPED SOILS TYPES - HOWARD COUNTY, MARYLAND

SYMBOL	NAME / DESCRIPTION	GROUP	HYDRIC	Kw	RANGE	PERCENT FARMLAND	<1% SLOPE W/ EROSION POTENTIAL
Bc	BLUSETT FINE SANDY LOAM, 5 TO 10% SLOPES	C	NO	0.43	NO	NO	YES
Sd	CASSAPRAS AND CROOM, 10 TO 15% SLOPES	B	NO	0.37	NO	NO	YES
Fpk	FALLSCHMIDT SANDY LOAM, 0 TO 2% SLOPES	D	YES	0.24	NO	NO	NO
Bkx	WACHUNG SILET LOAM, 0 TO 3% SLOPES	D	YES	0.43	NO	NO	NO
lB	LEGORE SILT LOAM, 3 TO 8% SLOPES	B	NO	0.64	NO	NO	YES
lC	LEGORE SILT LOAM, 8 TO 15% SLOPES	B	NO	0.64	NO	NO	YES
Cs	CLAYTON-LEGORE COMPLEX, 8 TO 15% SLOPES	B	NO	0.32	NO	NO	NO

NOTE:
 TAKEN FROM: USDA, SCS-WEB SOIL SURVEY, HOWARD COUNTY
<https://www.howardscs.org/documents>


HIGHLY ERODIBLE SOILS ARE THOSE SOILS WITH A SLOPE GREATER THAN 15 PERCENT OR THOSE SOILS WITH A SOIL ERODIBILITY FACTOR K GREATER THAN 0.35 AND WITH A SLOPE GREATER THAN 5 PERCENT

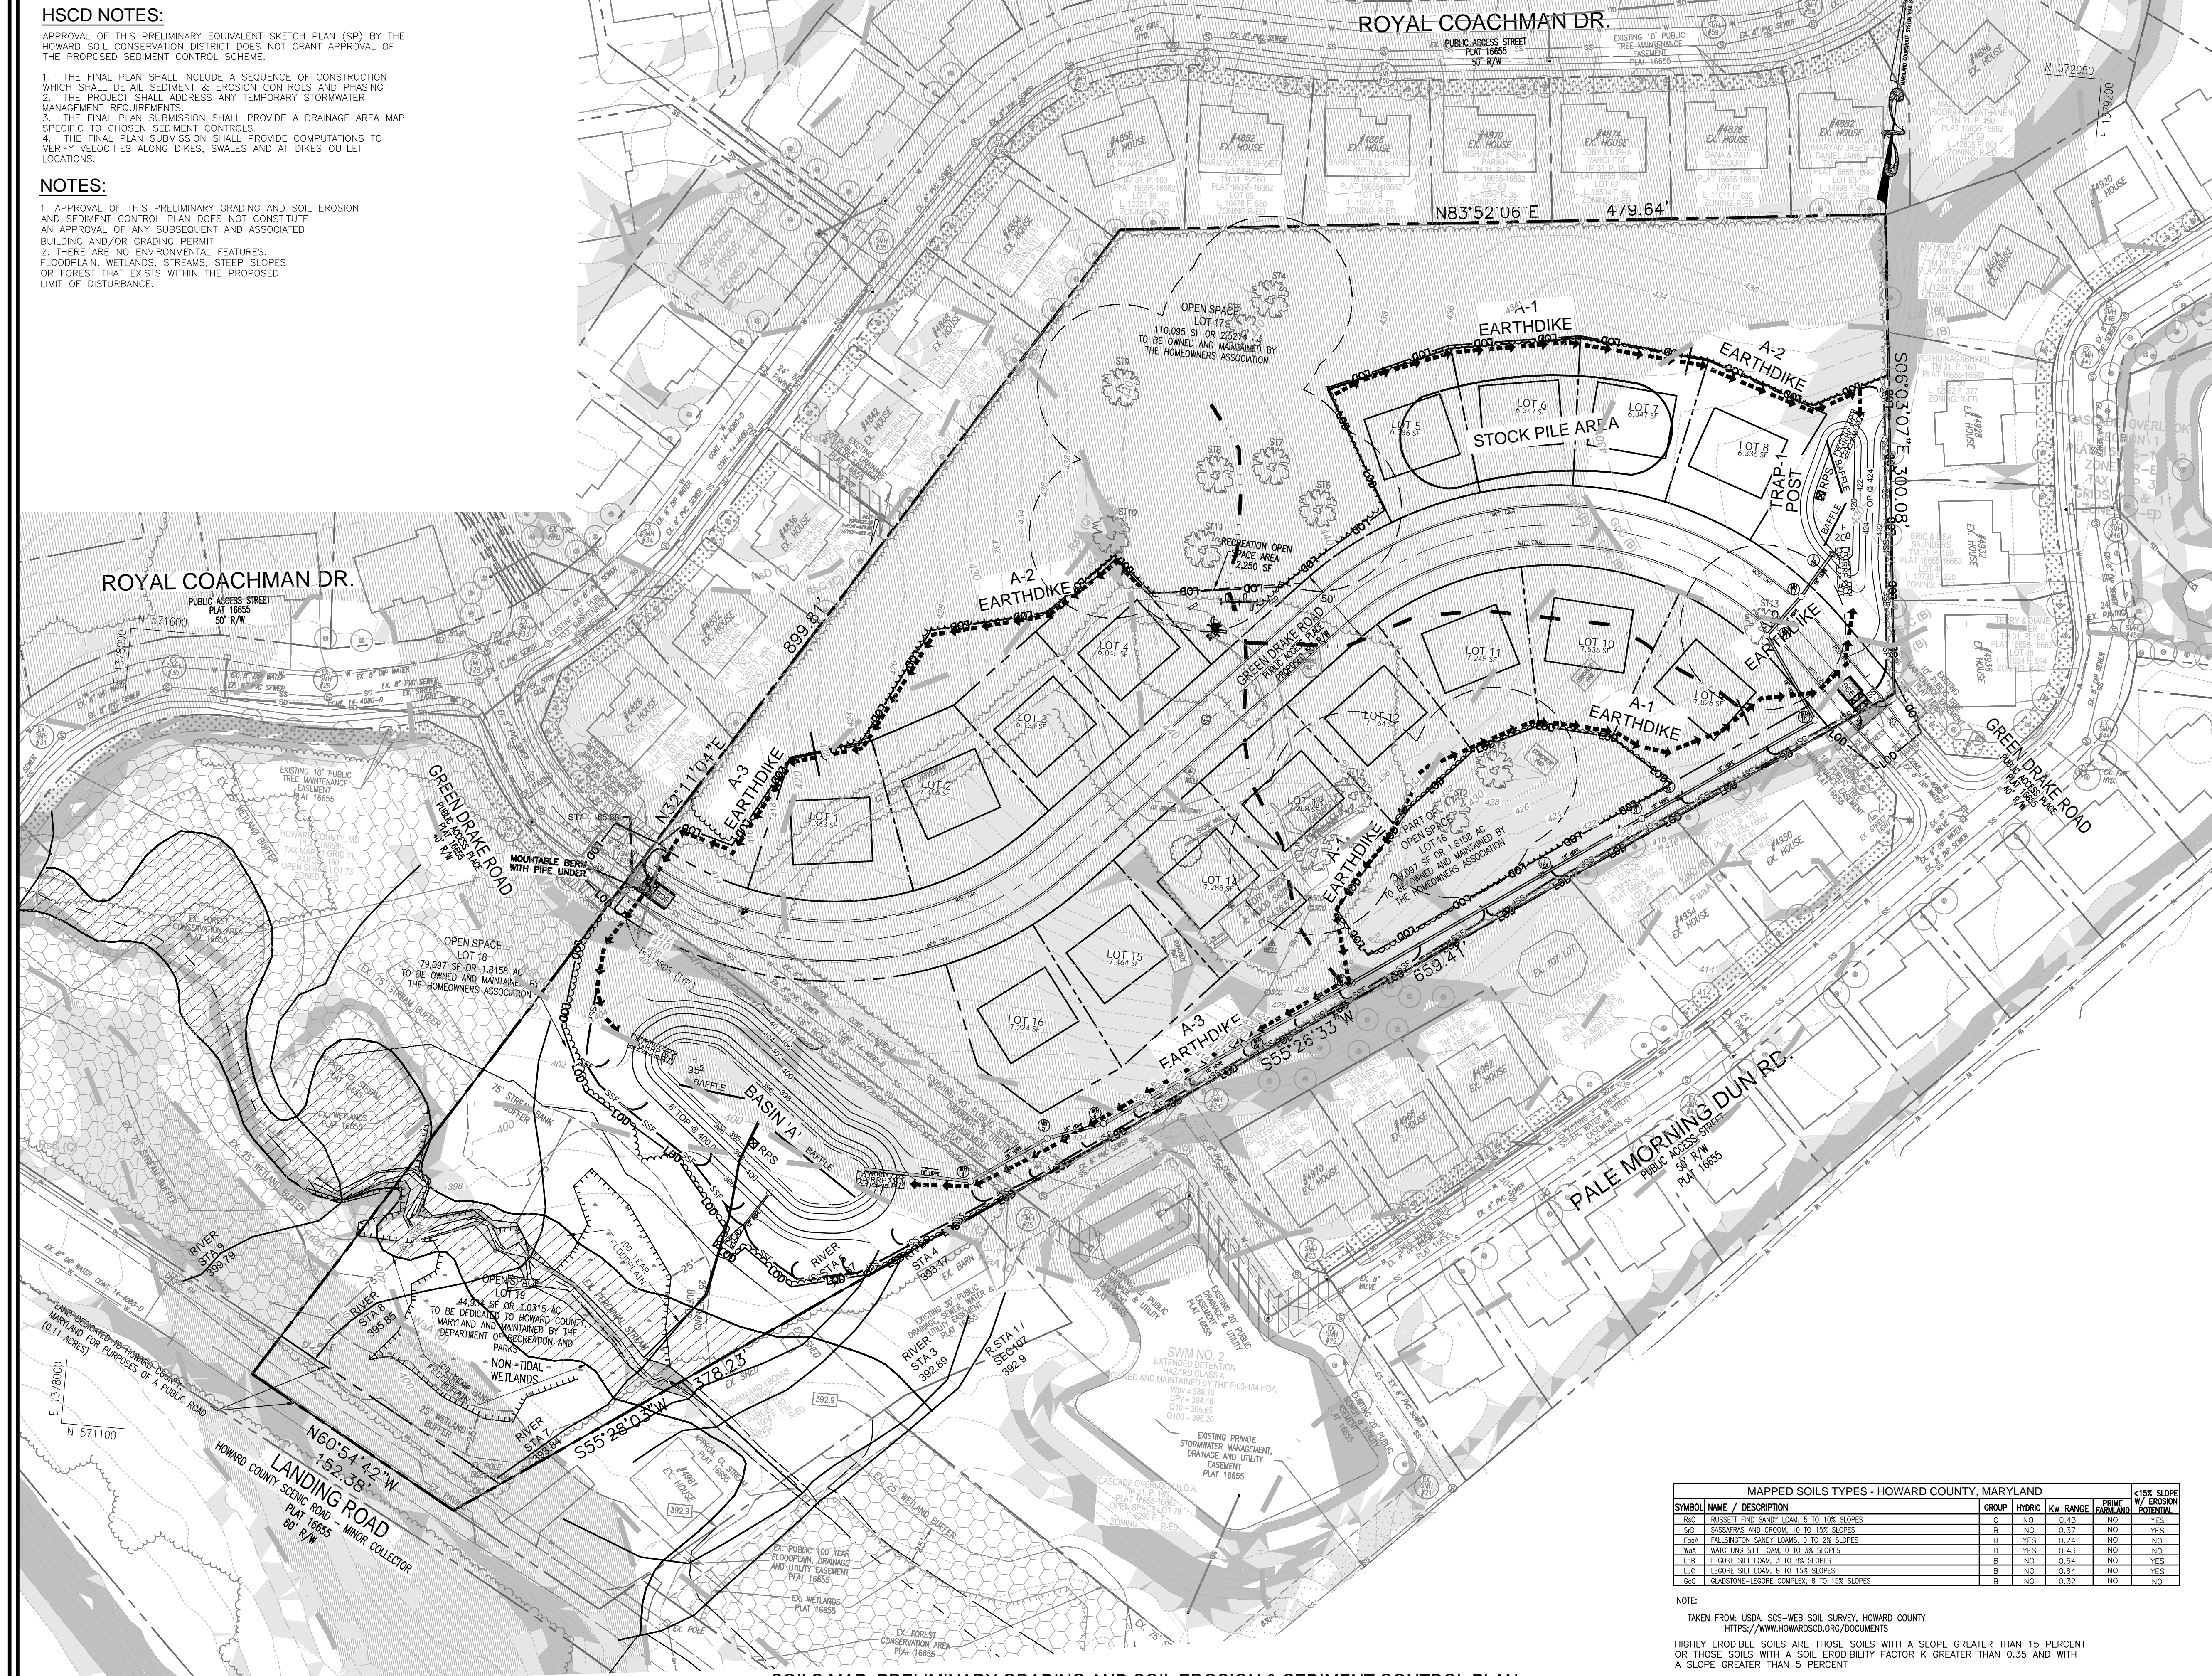

TENTATIVELY APPROVED
 DEPARTMENT OF PLANNING AND ZONING
 HOWARD COUNTY

PLANNING DIRECTOR _____ DATE _____

SOILS MAP, PRELIMINARY GRADING AND SOIL EROSION & SEDIMENT CONTROL PLAN

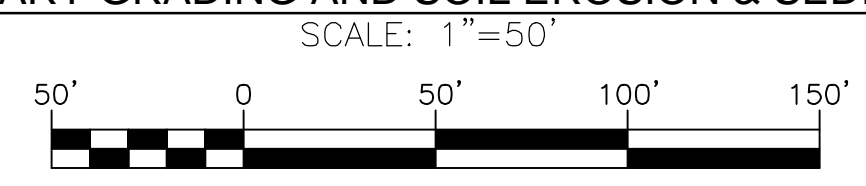

OWNER/DEVELOPER
 JOHN NEELS
 7330 GREEN DRAKE ROAD
 ELKRIE, MD 21075
 (410) 869-0134


PRELIMINARY SEQUENCE OF CONSTRUCTION

1. OBTAIN GRADING PERMIT. - 1 DAY
2. OBTAIN A NATIONAL POLLUTANT DISCHARGE ELIMINATION SYSTEM (NPDES) PERMIT - 1 DAY
3. DEVELOPER / CONTRACTOR SHALL REQUEST A PRE-CONSTRUCTION MEETING WITH THE APPROPRIATE ENFORCEMENT AUTHORITY PRIOR TO BEGINNING CONSTRUCTION. - 1 DAY
4. NOTIFY HOWARD COUNTY BUREAU OF INSPECTIONS AND PERMITS (410-313-1880) AT LEAST 24 HOURS BEFORE STARTING ANY WORK. - 1 DAY
5. STAKEOUT LIMITS OF DISTURBANCE. - 3 DAYS
6. INSTALL TWO (2) STABILIZED CONSTRUCTION ENTRANCES - 1 DAY
7. COMPLETE CLEARING AND GRUBBING FOR THE INSTALLATION OF PERIMETER CONTROLS ONLY. - 7 DAYS
8. INSTALL PERIMETER CONTROLS AT THE LIMIT OF DISTURBANCE, WHERE SHOWN OR AS DIRECTED BY THE SEDIMENT CONTROL INSPECTOR. - 14 DAYS
9. INSTALL STORM DRAIN SYSTEM AND OVERDRAIN SYSTEM ALONG SOUTH EAST BOUNDARY. - 5 DAYS
10. WITH PERMISSION OF THE SEDIMENT CONTROL INSPECTOR, COMPLETE THE CONSTRUCTION OF THE PROJECTS SEDIMENT TRAP AND SEDIMENT BASIN PER THE DETAILS AND SPECIFICATIONS. PRIOR TO THE ABOVE OUTFALLS RECEIVING TRAP DISCHARGE, THE RIP RAP OUTFALL INSTALLATION MUST BE COMPLETE. AREA STABILIZED AND PERMISSION MUST BE OBTAINED BY THE SEDIMENT CONTROL INSPECTOR. - 1 WEEK
11. INSTALL CLEANWATER DIVERSIONS. - 5 DAYS
12. EARTH DIKES DIRECTING SITE DISTURBANCES TO THE TRAPS SHALL BE CONSTRUCTED AT THE SAME TIME AS THE SEDIMENT TRAP. EARTH DIKES SHALL BE CONSTRUCTED STARTING AT THE TRAP AND OUT TO THE UPHILL MOST POINT.
13. DIKES SHALL BE LINED AS DETAIL HEREON. ANY TEMPORARY MATING IS MADE WITH DEGRADEABLE (6 MONTH), NATURAL OR MANAGED FIBERS OF UNIFORM THICKNESS AND DISTRIBUTION OF FIBERS THROUGHOUT AND IS SMALLER RESISTANT. - 1 DAY
14. STABILIZE THE DISTURBED AREAS FROM THE AFROMENTIONED DISTURBANCES WITH TEMPORARY SEEDING MIXTURE AND STRAW MULCH. - 2 DAYS
15. WITH TRAPS IN PLACE AND FUNCTIONING AND WITH THE PERMISSION OF THE SEDIMENT CONTROL INSPECTOR, COMPLETE REMAINING CLEARING AND GRUBBING. - 2 WEEKS
16. COMPLETE PROJECT MASS GRADING AS REQUIRED TO BRING SITE TO AT OR NEAR ROAD RIGHT-OF-WAY SUBGRADE ELEVATION. COMPLETE COMPACTED FILLS FOR PROPOSED HOME CONSTRUCTION.
17. AS ULTIMATE GRADINGS ARE ESTABLISHED, DISTURBANCES SHALL BE IMMEDIATELY STABILIZED WITH PERMANENT SEEDING MIXTURE AND STRAW MULCH. - 3 WEEKS
18. COMPLETE THE INSTALLATION OF SITE UTILITIES (WATER, SEWER AND STORM DRAIN) - 2 MONTHS
19. STABILIZE DISTURBANCES WITH PERMANENT SEEDING MIXTURE AND STRAW MULCH. - 1 DAY
20. ONCE GRADING OPERATIONS AND UTILITY DISTURBANCES ARE COMPLETE, DRESS ROAD RIGHT-OF-WAYS TO SUBGRADE ELEVATION AND INSTALL STONE SUBBASE IN PREPARATION FOR THE INSTALLATION OF ROADWAY CURBS & GUTTER. - 1 WEEK
21. CAREFULLY INSTALL CURBS AND GUTTER AND STABILIZE DISTURBANCES WITH PERMANENT SEEDING MIXTURE AND STRAW MULCH. PROJECT TRAPS CAN BE BACKFILLED WITH PERMISSION OF SEDIMENT CONTROL INSPECTOR. - 1 WEEK
22. COMPLETE THE INSTALLATION OF PROJECT DRY UTILITIES - 3 WEEKS
23. FINE GRADE AREAS FROM DRY UTILITY INSTALLATION ADD TOPSOIL PER THE SPECIFICATIONS SHOWN HEREON AND STABILIZE WITH PERMANENT SEEDING MIXTURE AND STRAW MULCH. - 3 DAYS
24. WITH CONTRIBUTING AREA STABILIZED, CONSTRUCT EXISTING MICRO-BORSTMENT/BO-SMALL FACILITIES WHICH RECEIVE ROAD RUNOFF OR RUNOFF FROM STABILIZED AREAS. ONCE CONSTRUCTED, PROTECT ANY INSTALLED ESD FACILITIES FROM RECEIVING "DIRTY" RUNOFF BY IMMEDIATELY STABILIZING FACILITY SIDE SLOPES WITH SOO AND SURROUND FACILITY WITH SILT FENCE. - 3 DAYS EACH
25. BEGON CONSTRUCTION OF INDIVIDUAL HOMES (REFER TO ASSOCIATED BUILDER SSP). PROTECT ANY INSTALLED ESD FACILITIES FROM RECEIVING "DIRTY" RUNOFF. 2 YEARS
26. INSTALLATION OF PROJECTS SIDEWALKS. - 1 MONTH
27. COMPLETE ANY FINE GRADING REQUIRED FROM DISTURBANCES MADE BY SIDEWALK INSTALLATION. ADD TOPSOIL PER THE SPECIFICATIONS SHOWN HEREON AND STABILIZE WITH PERMANENT SEEDING MIXTURE AND STRAW MULCH. - ONLY
28. UPON COMPLETION OF PROJECT HOME CONSTRUCTION AND WITH PERMISSION OF THE SEDIMENT CONTROL INSPECTOR, COMPLETE ANY REMAINING FINE GRADING IN ACCORDANCE WITH STORMWATER MANAGEMENT CRITERIA ADD TOPSOIL PER THE SPECIFICATIONS SHOWN HEREON, AND STABILIZE DISTURBED AREAS WITH PERMANENT SEEDING MIXTURE AND STRAW MULCH. - 1 WEEK
29. COMPLETE INSTALLATION OF PROJECTS LANDSCAPE PLANTING REQUIREMENTS - 1 MONTH
30. AFTER PERMISSION HAS BEEN GIVEN BY SEDIMENT CONTROL INSPECTOR, REMOVE ANY REMAINING E/S CONTROLS AND STABILIZE THE DISTURBED AREAS FROM THE AFROMENTIONED DISTURBANCES WITH PERMANENT SEEDING MIXTURE AND STRAW MULCH. - ONLY

NOTE: ANY CHANGES OR REVISIONS TO THE SEQUENCE OF CONSTRUCTION MUST BE REVIEWED AND APPROVED BY THE PLAN APPROVAL AUTHORITY PRIOR TO PROCEEDING WITH CONSTRUCTION

LEGEND:

- PROPERTY LINE
- RIGHT-OF-WAY LINE
- ADJACENT PROPERTY LINE
- EXISTING PAVING
- EXISTING UTILITY POLE
- EXISTING SANITARY MANHOLE
- EXISTING SANITARY LINE
- EXISTING FIRE HYDRANT
- EXISTING WATER LINE
- EXISTING 10' CONTOUR
- EXISTING 2' CONTOUR
- SOILS
- EXISTING TREELINE
- CENTERLINE OF EXISTING STREAM
- EXISTING SPECIMEN TREE WITH CRITICAL ROOT ZONE
- EXISTING WETLANDS
- EXISTING WETLAND BUFFER
- EX. PUBLIC 100-YEAR FLOODPLAIN
- EXISTING FOREST CONSERVATION EASEMENT (PLAT 16655)
- PROPOSED STORMDRAIN
- PROPOSED SIDEWALK
- PROPOSED TREELINE
- PROPOSED CURB
- PROPOSED 10' CONTOUR
- PROPOSED 2' CONTOUR
- LIMIT OF DISTURBANCE
- STABILIZED CONSTRUCTION ENTRANCE W/ MOUNTABLE BERM
- RIPRAP PROTECTION
- BAFFLE
- REMOVABLE PUMPING STATION
- SUPER SILT FENCE
- SILT FENCE
- EARTHDIKE
- HIGHLY ERODIBLE SOILS
- EXISTING PUBLIC SEWER, WATER DRAINAGE & UTILITY EASEMENT (PLAT 16655)
- MODERATE SLOPES (15%-24.9%)
- STEEP SLOPES (>25%)
- DRAINAGE DIVIDE

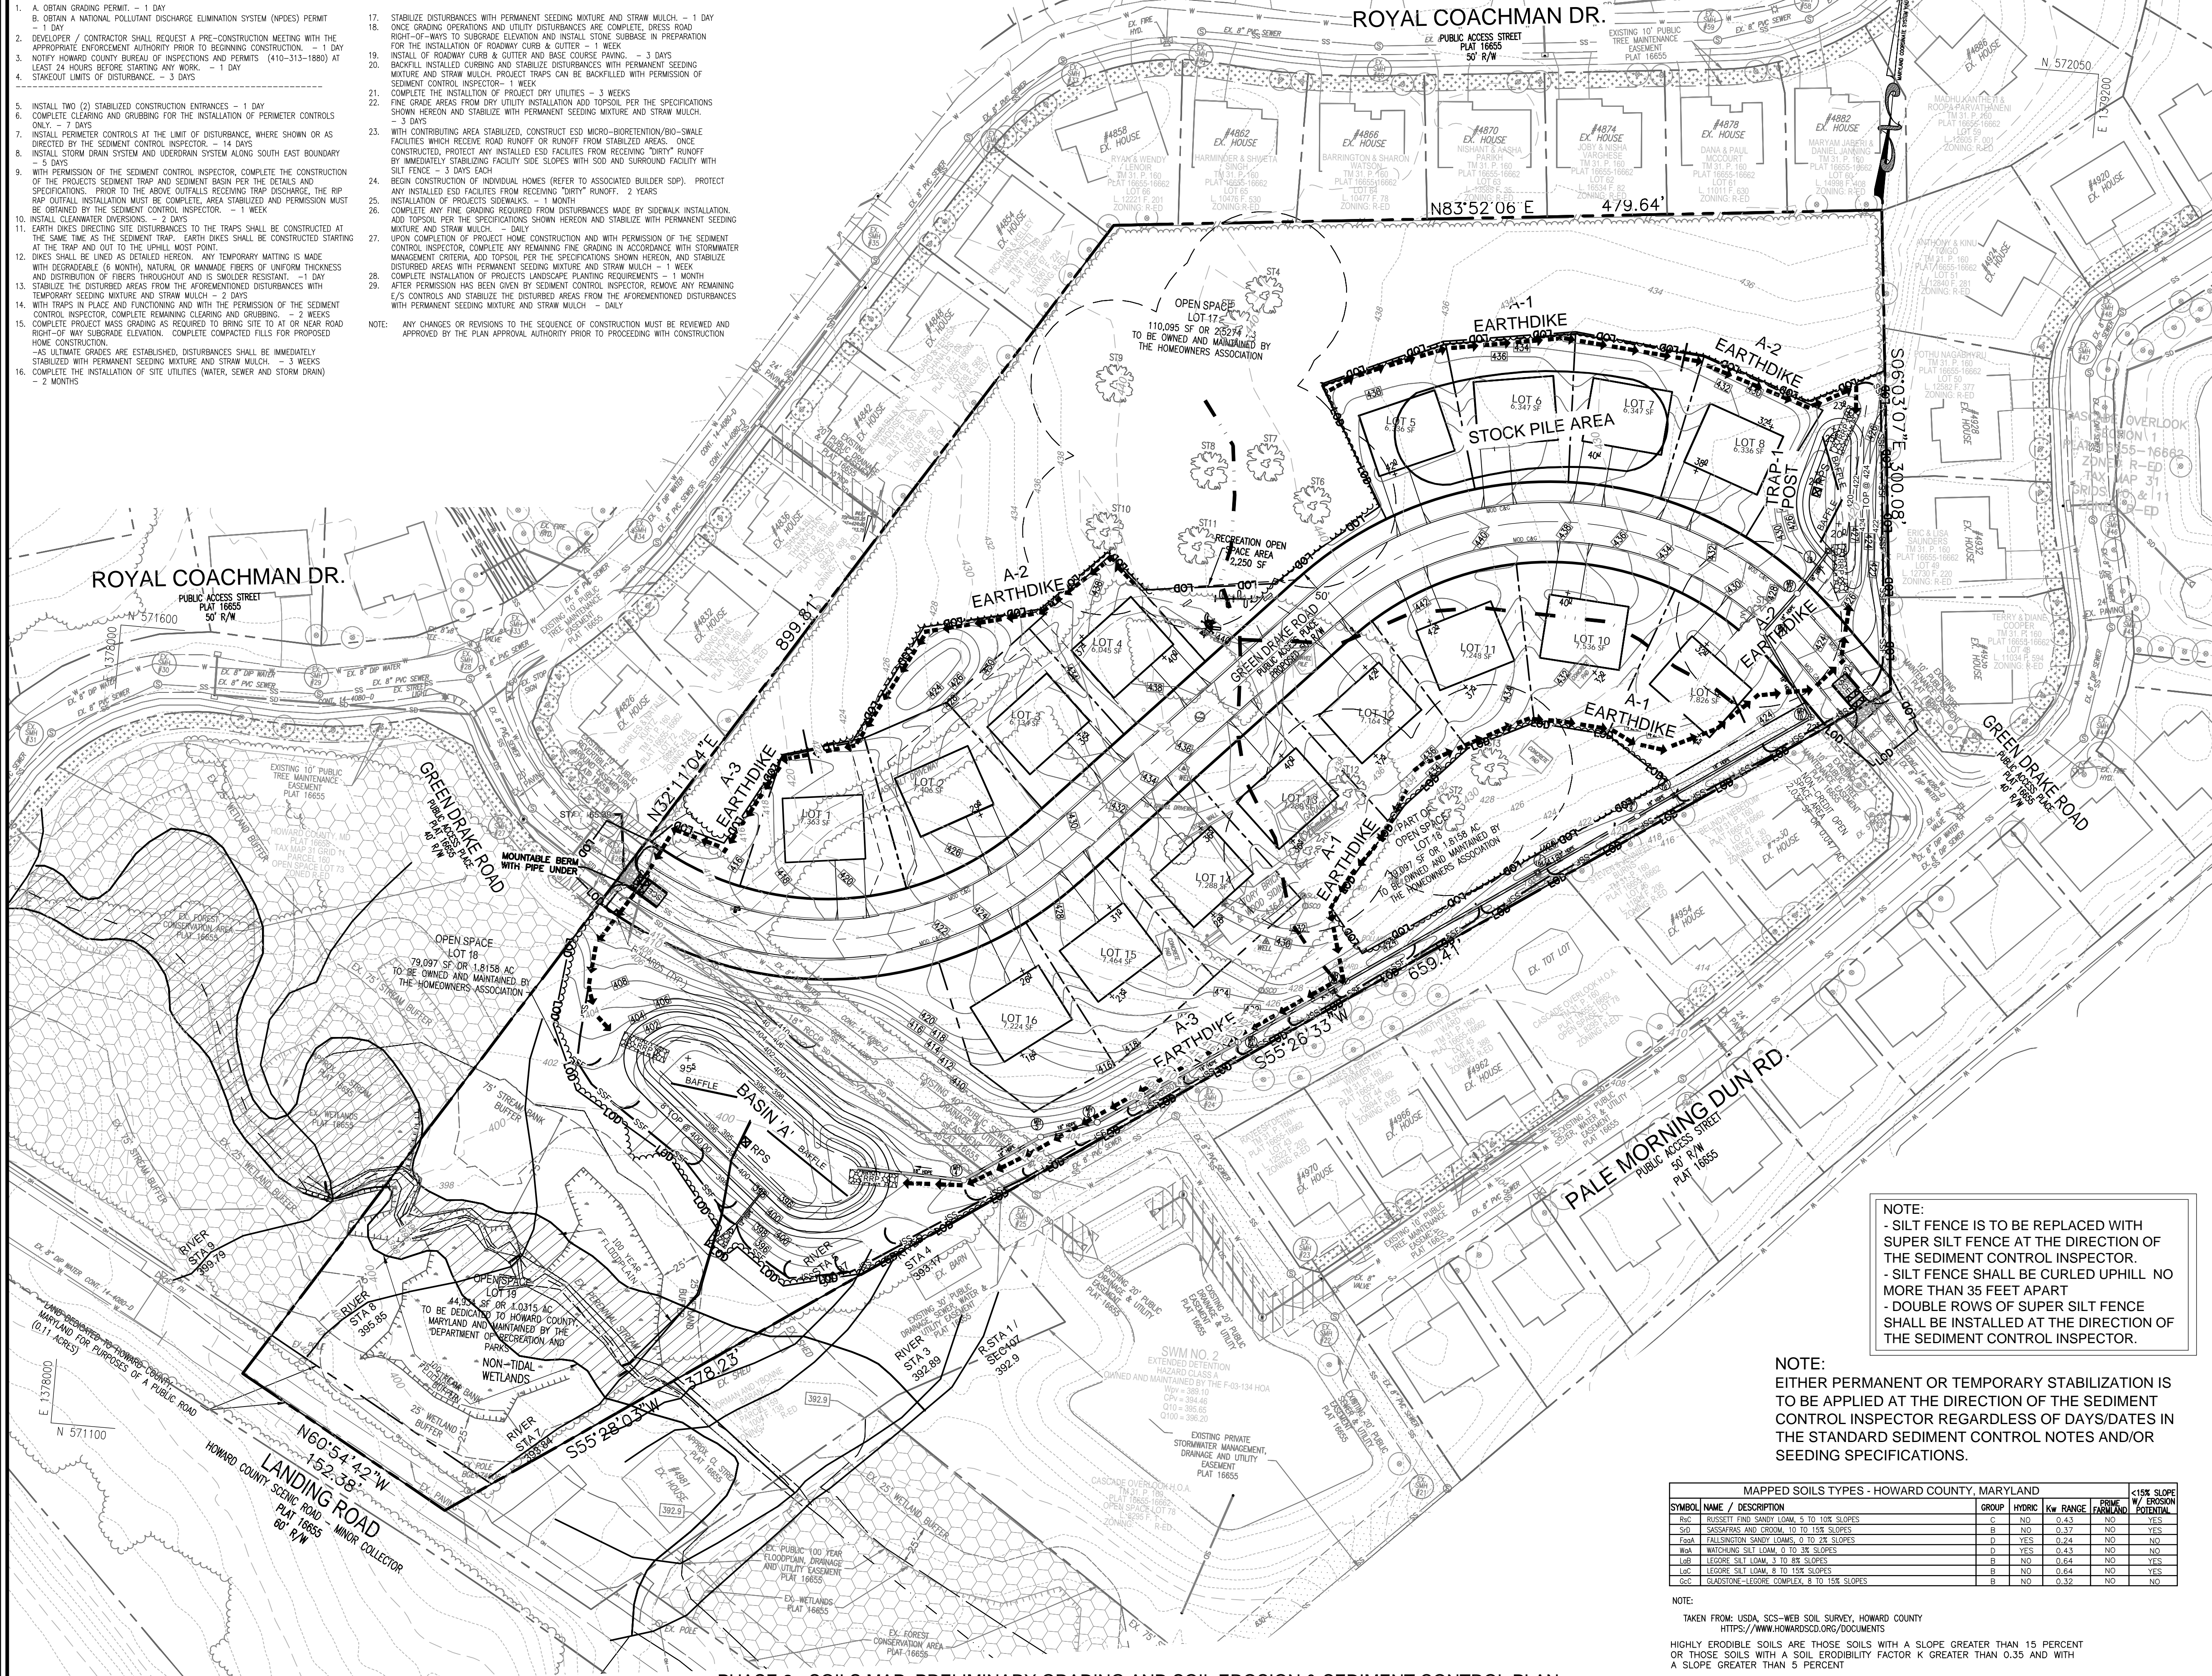

NOTE:
 - SILT FENCE IS TO BE REPLACED WITH SUPER SILT FENCE AT THE DIRECTION OF THE SEDIMENT CONTROL INSPECTOR.
 - SILT FENCE SHALL BE CURLED UPHILL NO MORE THAN 35 FEET APART
 - DOUBLE ROWS OF SUPER SILT FENCE SHALL BE INSTALLED AT THE DIRECTION OF THE SEDIMENT CONTROL INSPECTOR.

NOTE:
 EITHER PERMANENT OR TEMPORARY STABILIZATION IS TO BE APPLIED AT THE DIRECTION OF THE SEDIMENT CONTROL INSPECTOR REGARDLESS OF DAYS/DATES IN THE STANDARD SEDIMENT CONTROL NOTES AND/OR SEEDING SPECIFICATIONS.

MAPPED SOILS TYPES - HOWARD COUNTY, MARYLAND		GROUP	HYDRIC	Kw RANGE	PRIME FERTILITY	<1% SLOPE W/ EROSION POTENTIAL
Sbc	RUSSETT FINE SANDY LOAM, 5 TO 10% SLOPES	C	NO	0.43	NO	YES
Sd	SASSAPARA AND CROOM, 10 TO 15% SLOPES	B	NO	0.37	NO	YES
Tcpa	FALLINGBUSH SANDY LOAMS, 0 TO 2% SLOPES	D	YES	0.24	NO	NO
Bka	WACHING SILE LOAM, 0 TO 2% SLOPES	D	YES	0.43	NO	NO
Lub	LEGORE SILT LOAM, 3 TO 8% SLOPES	B	NO	0.64	NO	YES
Lsc	LEGORE SILT LOAM, 8 TO 15% SLOPES	B	NO	0.64	NO	YES
Sbc	GLASTON-LEGORE COMPLEX, 8 TO 15% SLOPES	B	NO	0.32	NO	NO

NOTE:
 TAKEN FROM: USDA, SOCS-WEB SOIL SURVEY, HOWARD COUNTY
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HIGHLY ERODIBLE SOILS ARE THOSE SOILS WITH A SLOPE GREATER THAN 15 PERCENT OR THOSE SOILS WITH A SOIL ERODIBILITY FACTOR K GREATER THAN 0.35 AND WITH A SLOPE GREATER THAN 5 PERCENT

NOTE:
 AS DIRECTED BY THE SEDIMENT CONTROL INSPECTOR, MORE STRINGENT SEEDING AND STABILIZATION MAY BE EXPECTED FOR AREAS OF HIGHLY ERODIBLE SOILS.


OWNER/DEVELOPER
 JOHN NEELS
 7330 GREEN DRAKE ROAD
 ELK RIDGE, MD 21075
 (410) 869-0134

TENTATIVELY APPROVED
 DEPARTMENT OF PLANNING AND ZONING
 HOWARD COUNTY

PLANNING DIRECTOR _____ DATE _____

NOTES:

1. APPROVAL OF THIS PRELIMINARY GRADING AND SOIL EROSION AND SEDIMENT CONTROL PLAN DOES NOT CONSTITUTE AN APPROVAL OF ANY SUBSEQUENT AND ASSOCIATED BUILDING AND/OR GRADING PERMIT
2. THERE ARE NO ENVIRONMENTAL FEATURES: FLOODPLAIN, WETLANDS, STREAMS, STEEP SLOPES OR FOREST THAT EXISTS WITHIN THE PROPOSED LIMIT OF DISTURBANCE.

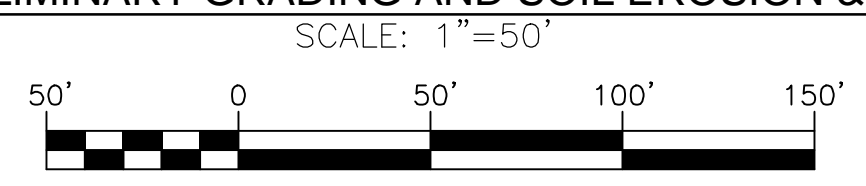

PHASE 2 - SOILS MAP, PRELIMINARY GRADING AND SOIL EROSION & SEDIMENT CONTROL PLAN

SEQUENCE OF CONSTRUCTION NOTES:

1. THE SEDIMENT SHALL BE REMOVED FROM THE SEDIMENT TRAPS WHEN THE CLEANOUT ELEVATION HAS BEEN REACHED. - DAILY
2. THE CONTRACTOR SHALL INSPECT AND PROVIDE NECESSARY MAINTENANCE ON THE SEDIMENT AND EROSION CONTROLS SHOWN HEREON AFTER EACH RAINFALL AND ON A DAILY BASIS. - DAILY
3. THE SEDIMENT TRAPS SHALL BE DEWATERED BY PUMPING. THE ACCUMULATED SEDIMENT SHALL BE PLACED UP GRADE FROM THE STRUCTURE IN SUCH A MANNER AS NOT TO INTERFERE WITH CONSTRUCTION OPERATIONS OR CAUSE EROSION DOWN GRADE FROM THE STRUCTURE. - DAILY
4. EARTH DIKES DIRECTING SITE DISTURBANCES TO THE TRAPS SHALL BE CONSTRUCTED AT THE SAME TIME AS THE SEDIMENT TRAPS. EARTH DIKES SHALL BE LINED AS DETAIL HEREON. TEMPORARY MATING IS MADE WITH DEGRADEABLE (6 MONTH), NATURAL OR MANAGED FIBERS OF UNIFORM THICKNESS AND DISTRIBUTION OF FIBERS THROUGHOUT AND IS SMALLER RESISTANT. - 1 DAY
5. AS ULTIMATE GRADINGS BETWEEN CONTROLS AND THE LOD ARE ESTABLISHED, THESE DISTURBANCES SHALL BE IMMEDIATELY STABILIZED WITH PERMANENT SEEDING MIXTURE AND STRAW MULCH. CONSTRUCTION IN TRAP AREAS SHALL BE DELAYED UNTIL ALL CONTRIBUTING AREAS ARE STABILIZED OR PERMISSION HAS BEEN GIVEN BY THE SEDIMENT CONTROL INSPECTOR. - DAILY
6. PLACE MICROBORSTMENT FACILITIES TO GRADE WHICH ALLOWS FEEDING STORM DRAINS TO FUNCTION. THESE FACILITIES SHALL BE CONSTRUCTED AT A LATER STAGE. STABILIZE DISTURBANCES WITH PERMANENT SEEDING MIXTURE AND STRAW MULCH. MICROBORSTMENT FACILITIES SHOULD NOT BE EXCAVATED TO BOTTOM ELEVATION ONLY THE MULCH ELEVATION WHICH WILL ALLOW THE INCOMING PIPES TO FUNCTION AND DRAIN TO THE FACILITY OUTLET. - DAILY
7. TRAPS SHALL REMAIN AS DIRECTED BY SEDIMENT CONTROL INSPECTOR AND SHALL BE BACKFILLED WITH PERMISSION OF SEDIMENT CONTROL INSPECTOR AS ULTIMATE GRADINGS ARE ESTABLISHED. ALL CONTRIBUTING AREAS ARE STABILIZED. TRAPS SHALL BE REPLACED WITH SUPER SILT FENCE AT THE LIMITS OF DISTURBANCE AS SUPPORTING SLOPES ARE SET TO FINAL GRADE. WITH SLOPES AT GRADE, IMMEDIATELY STABILIZE WITH PERMANENT SEEDING MIXTURE AND STRAW MULCH. - 2 WEEK

NO.	REVISION	DATE

PRELIMINARY EQUIVALENT SKETCH PLAN
 PHASE 2 - SOILS MAP, PRELIMINARY GRADING
 AND SOIL EROSION & SEDIMENT CONTROL PLAN
CASCADE RIDGE
 LOTS 1-16 AND OPEN SPACE LOTS 17 - 19
 7330 GREEN DRAKE ROAD
 ELK RIDGE, MD 21075

PARCEL: 474
 TAX MAP: 31 GRID: 11
 1ST ELECTION DISTRICT

ZONED: R-ED
 L 362 / F. 260
 HOWARD COUNTY, MARYLAND

VOGEL ENGINEERING
 TIMMONS GROUP

3300 NORTH RIDGE ROAD, SUITE 110, ELLIOTT CITY, MD 21043
 P: 410.461.7666 F: 410.461.8961 www.timmongroup.com


PROFESSIONAL CERTIFICATE

DESIGN BY: RHV
 DRAWN BY: MDL VETG
 CHECKED BY: RHV
 DATE: JANUARY 2020
 SCALE: AS SHOWN
 W.O. NO.: 42148



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5 SHEET OF 10



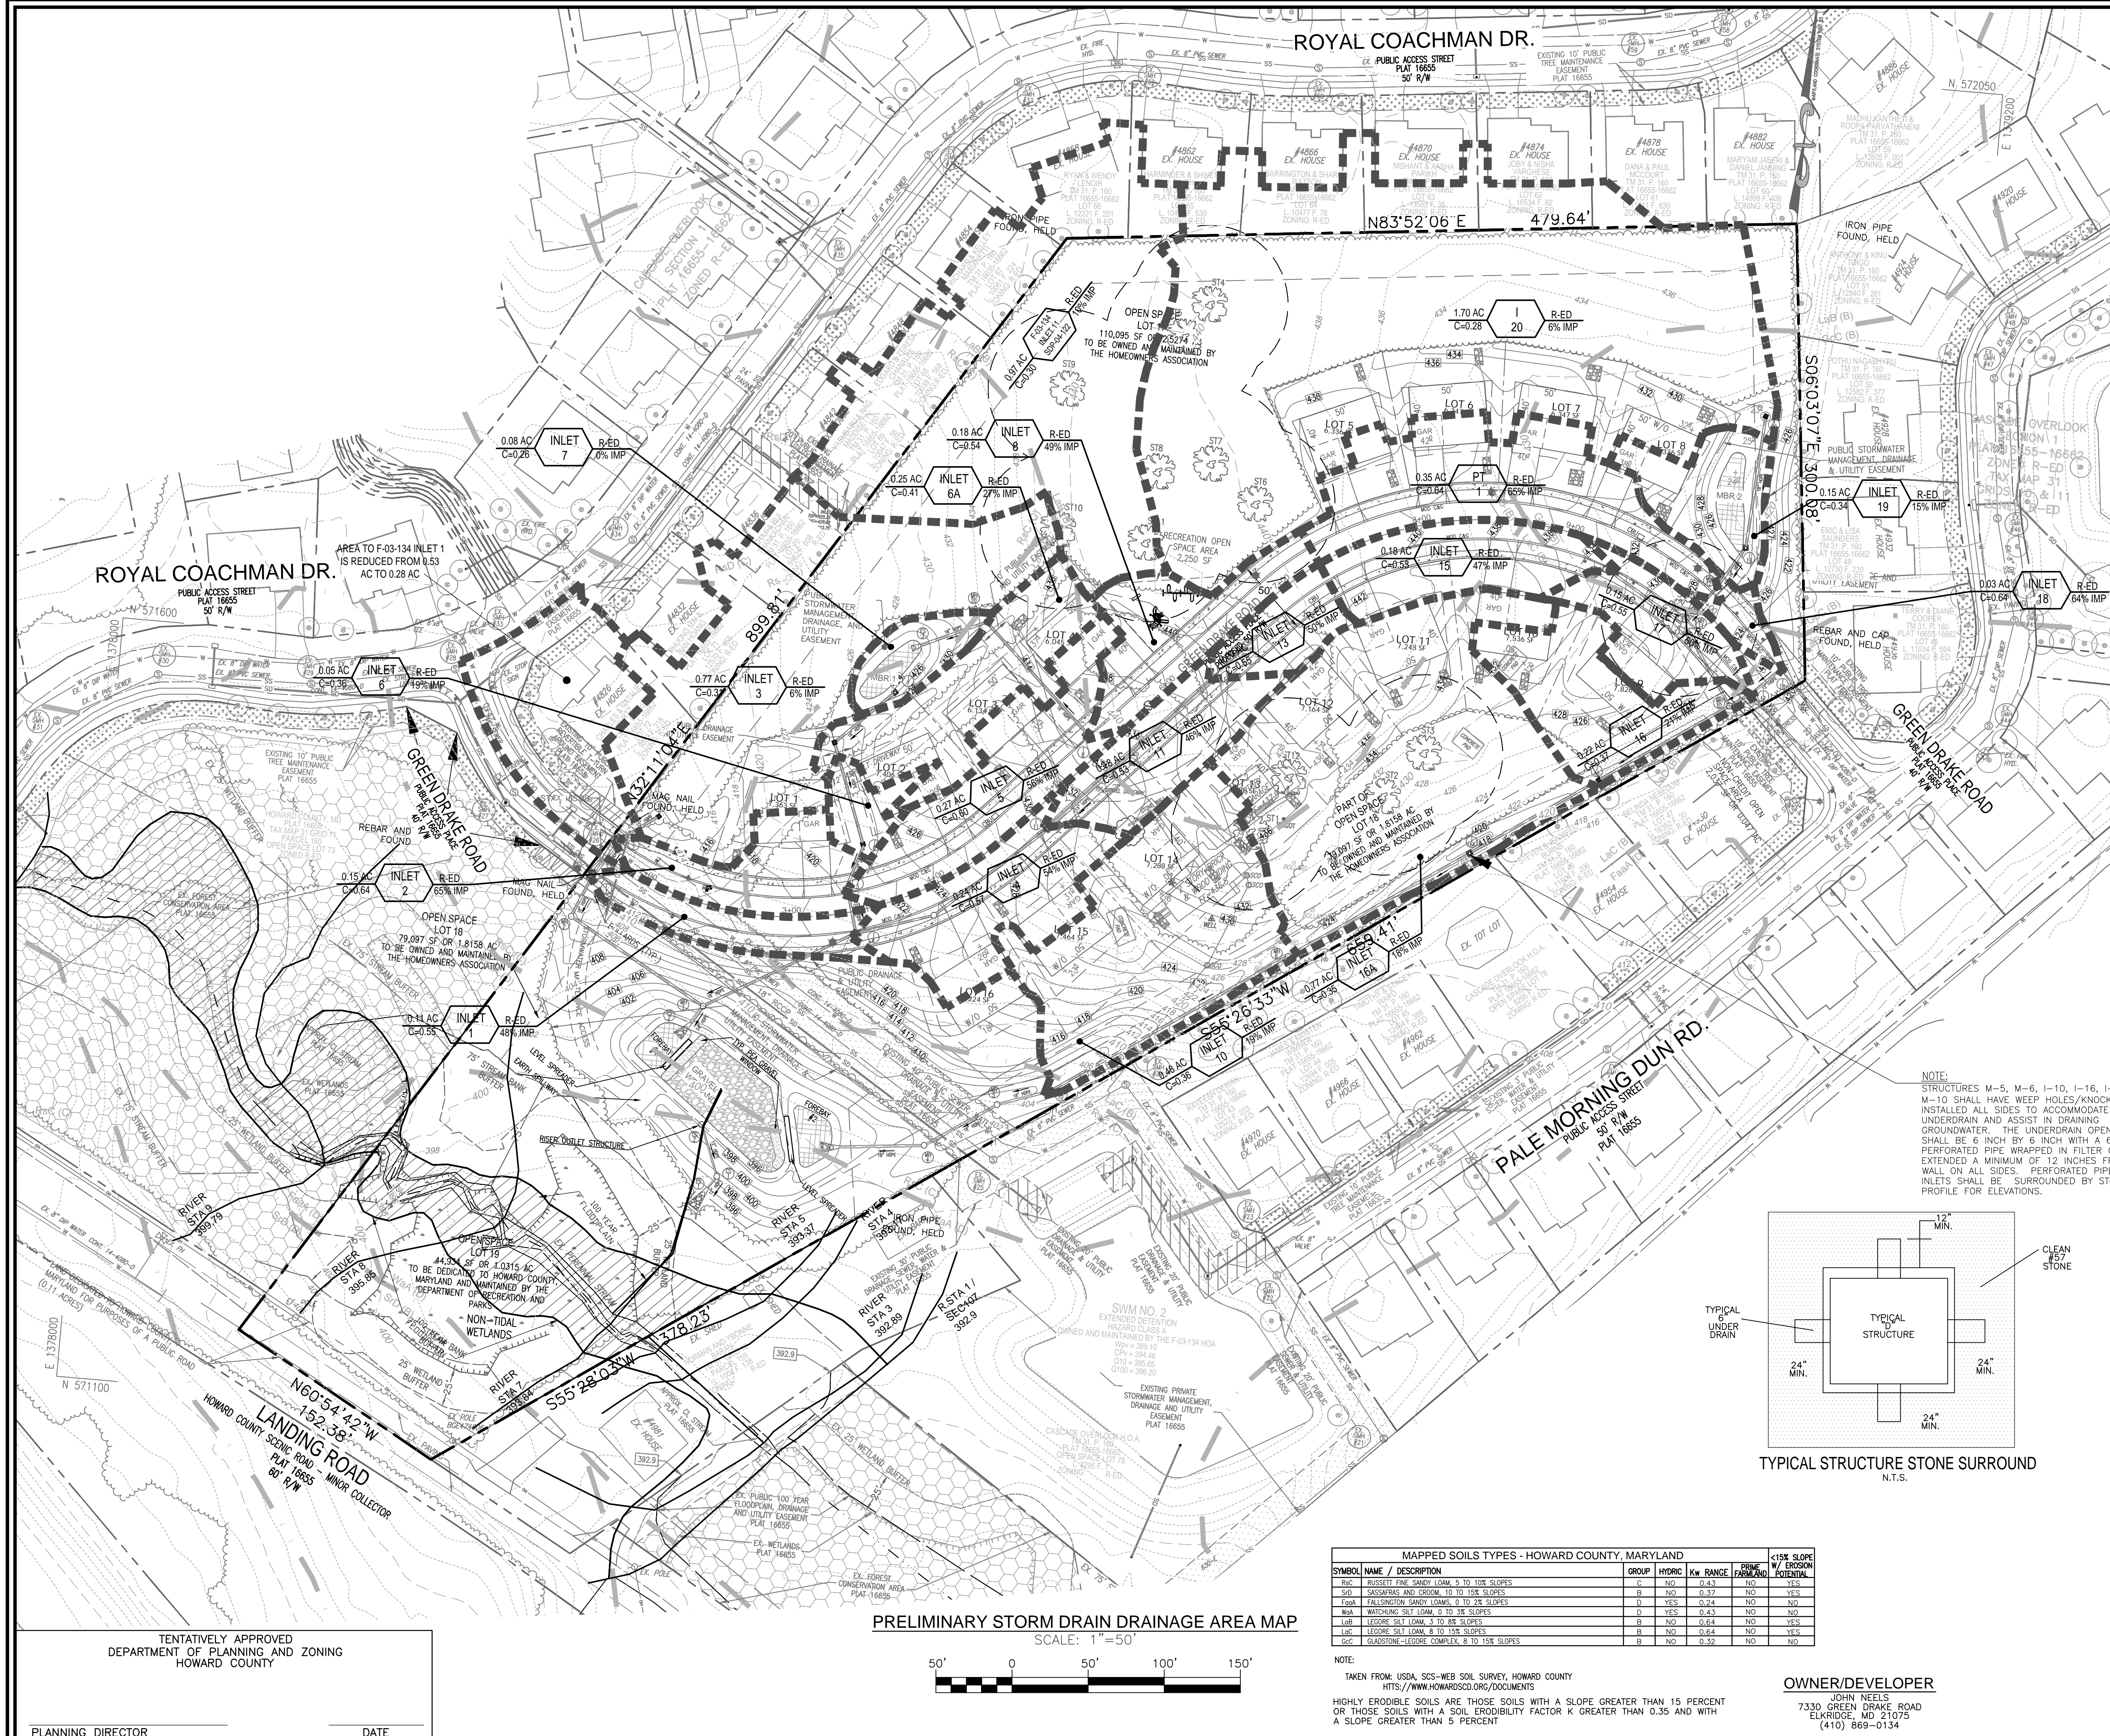

- LEGEND:**
- PROPERTY LINE
 - RIGHT-OF-WAY LINE
 - ADJACENT PROPERTY LINE
 - EXISTING PAVING
 - EXISTING UTILITY POLE
 - EXISTING SANITARY MANHOLE
 - EXISTING SANITARY LINE
 - EXISTING FIRE HYDRANT
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 - EXISTING 10' CONTOUR
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 - CENTERLINE OF EXISTING STREAM
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 - EXISTING WETLAND BUFFER
 - EX. PUBLIC 100-YEAR FLOOD PLAN
 - EXISTING FOREST CONSERVATION EASEMENT (PLAT 16655)
 - PROPOSED STORM DRAIN
 - PROPOSED SIDEWALK
 - PROPOSED TREE LINE
 - PROPOSED CURB
 - PROPOSED 10' CONTOUR
 - PROPOSED 2' CONTOUR
 - SPLITTER MANHOLE
 - DRAINAGE AREA
 - AREA INLET ZONE
 - EXISTING PUBLIC SEWER, WATER DRAINAGE & UTILITY EASEMENT (PLAT 16655)
 - MODERATE SLOPES (15% - 24.9%)
 - STEEP SLOPES (>25%)

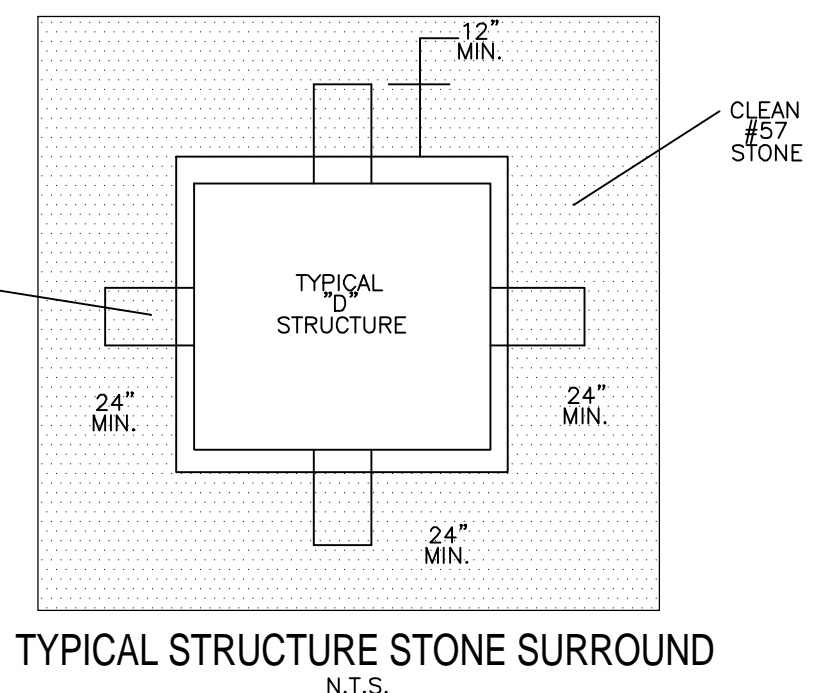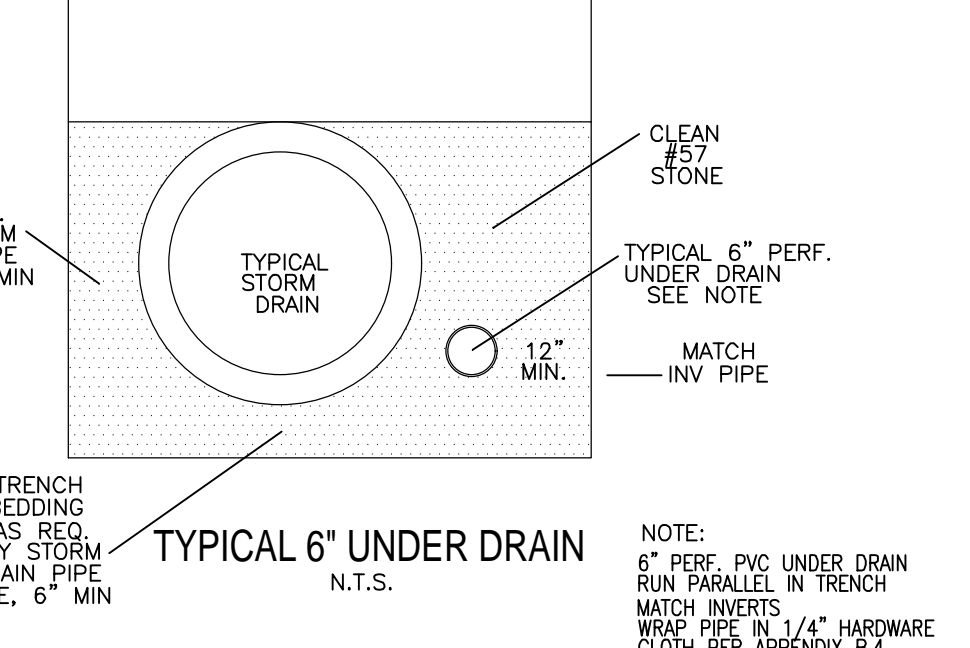

NOTE:
STRUCTURES M-5, M-6, I-10, I-15, I-16A AND M-10 SHALL HAVE WEEP HOLES/KNOCK OUTS INSTALLED ALL SIDES TO ACCOMMODATE UNDERDRAIN AND ASSIST IN DRAINING GROUNDWATER. THE UNDERDRAIN OPENINGS SHALL BE 6 INCH BY 6 INCH WITH A 6 INCH PERFORATED PIPE WRAPPED IN FILTER CLOTH, EXTENDED A MINIMUM OF 12 INCHES FROM THE WALL ON ALL SIDES. PERFORATED PIPE AND INLETS SHALL BE SURROUNDED BY STONE. SEE PROFILE FOR ELEVATIONS.

NO.	REVISION	DATE

PRELIMINARY EQUIVALENT SKETCH PLAN
PRELIMINARY STORM DRAIN DRAINAGE AREA MAP
CASCADE RIDGE
LOTS 1-16 AND OPEN SPACE LOTS 17 - 19
7330 GREEN DRAKE ROAD
ELK RIDGE, MD 21075

PARCEL: 474
TAX MAP: 31 GRID: 11
1ST ELECTION DISTRICT

ZONED: R-ED
L 362 / F. 260
HOWARD COUNTY, MARYLAND

VOGEL ENGINEERING
TIMMONS GROUP
3300 NORTH RIDGE ROAD, SUITE 110, ELLIOTT CITY, MD 21043
P: 410-461-7666 F: 410-461-8961 www.timmons.com

DESIGN BY: RHV
DRAWN BY: MDL VETG
CHECKED BY: RHV
DATE: JANUARY 2020
SCALE: AS SHOWN
W.O. NO.: 42148

PROFESSIONAL CERTIFICATE
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6 SHEET OF 10

MAPPED SOILS TYPES - HOWARD COUNTY, MARYLAND

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T10A FALLINGBOM SANDY LOAMS, 0 TO 2% SLOPES	D	YES	0.24	NO
M1A WATCHING SILE LOAM, 0 TO 3% SLOPES	D	YES	0.43	NO
L1B LEGORE SILT LOAM, 3 TO 8% SLOPES	B	NO	0.64	YES
L1C LEGORE SILT LOAM, 8 TO 15% SLOPES	B	NO	0.64	NO
G1C GLASTONE-LEGORE COMPLEX, 8 TO 15% SLOPES	B	NO	0.32	NO

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TENTATIVELY APPROVED
DEPARTMENT OF PLANNING AND ZONING
HOWARD COUNTY

PLANNING DIRECTOR _____ DATE _____

PRELIMINARY STORM DRAIN DRAINAGE AREA MAP
SCALE: 1"=50'
50' 0 50' 100' 150'

LANDSCAPE NOTES

1. AT THE TIME OF PLANT INSTALLATION, ALL SHRUBS AND TREES LISTED AND APPROVED ON THE LANDSCAPE PLAN SHALL COMPLY WITH THE PROPER HEIGHT REQUIREMENT IN ACCORDANCE WITH THE HOWARD COUNTY LANDSCAPE MANUAL. IN ADDITION, NO SUBSTITUTIONS OR RELOCATIONS OF THE REQUIRED PLANTINGS MAY BE MADE WITHOUT PRIOR REVIEW AND APPROVAL FROM THE DEPARTMENT OF PLANNING AND ZONING, ANY DEVIATION FROM THE APPROVED LANDSCAPE PLAN MAY RESULT IN DENIAL OR DELAY IN THE RELEASE OF LANDSCAPE SURETY UNTIL SUCH TIME AS ALL REQUIRED MATERIALS ARE PLANTED AND/OR REVISIONS ARE MADE TO THE APPLICABLE PLANS.
2. THE OWNER, TENANT AND/OR THEIR AGENTS SHALL BE RESPONSIBLE FOR MAINTENANCE OF THE REQUIRED LANDSCAPING INCLUDING BOTH PLANT MATERIALS AND BERMS, FENCES AND WALLS. ALL PLANT MATERIALS SHALL BE MAINTAINED IN GOOD GROWING CONDITION, AND WHEN NECESSARY, REPLACED WITH NEW MATERIALS TO ENSURE CONTINUED COMPLIANCE WITH APPLICABLE REGULATIONS. ALL OTHER REQUIRED LANDSCAPING SHALL BE PERMANENTLY MAINTAINED IN GOOD CONDITION, AND WHEN NECESSARY, REPAIRED OR REPLACED.
3. SHOULD ANY TREE DESIGNATED FOR PRESERVATION FOR WHICH LANDSCAPING CREDIT IS GIVEN, DIE PRIOR TO RELEASE OF BONDS, THE OWNER WILL BE REQUIRED TO REPLACE THE TREE WITH THE EQUIVALENT SPECIES OR WITH A TREE WHICH WILL OBTAIN THE SAME HEIGHT, SPREAD, AND GROWTH CHARACTERISTICS. THE REPLACEMENT TREE MUST BE A MINIMUM OF 3 INCHES IN CALIPER AND INSTALLED AS REQUIRED IN THE HOWARD COUNTY LANDSCAPE MANUAL.
4. PLANTINGS SHOWN HEREON ARE THE RESPONSIBILITY OF THE DEVELOPER TO INSTALL DURING THE CONSTRUCTION OF THE FINAL PLAN.
5. SPECIFIC TREE TYPES AND SPECIES SHALL BE PROVIDED WITH THE FINAL LANDSCAPE PLAN AND DETAILS.

SPECIMEN TREE CHART

TREE	SPECIES	SIZE (IN. DBH)	CRZ (FT. RADIUS)	COMMENTS
ST-1	SILVER MAPLE	53	79.5	POOR CONDITION, MAJOR DIEBACK - TO BE REMOVED
ST-2	ENGLISH WALNUT	37	55.5	POOR CONDITION, OLD LIGHTNING STRIKE, DIEBACK AND ROT - TO REMAIN
ST-3	ENGLISH WALNUT	35.5	53.25	FAIR CONDITION - TO REMAIN
ST-4	TULIP POPLAR	30	45	GOOD CONDITION - TO REMAIN
ST-5	TULIP POPLAR	34.5	51.75	GOOD CONDITION - TO REMAIN
ST-6	AMERICAN BEECH	43.5	65.25	VERY POOR, MAJOR ROT - TO REMAIN
ST-7	TULIP POPLAR	53.3	79.95	VERY POOR, MAJOR ROT - TO REMAIN
ST-8	TULIP POPLAR	58	87	FAIR CONDITION, LIMB DAMAGE, LIMITED CROWN - TO REMAIN
ST-9	TULIP POPLAR	34	51	FAIR CONDITION, DIEBACK, LIMITED CROWN - TO REMAIN
ST-10	WHITE ASH	43	64.5	POOR CONDITION, NOTABLE DIEBACK, BORER ACTIVITY NOTED - TO REMAIN
ST-11	AMERICAN BEECH	36.5	54.75	POOR CONDITION, SEVERE TRUNK ROT - TO REMAIN
ST-12	SILVER MAPLE	48	72	POOR CONDITION, MAJOR DIEBACK, FENCED INTO OLD PET RUN - TO BE REMOVED
ST-13	TULIP POPLAR	33	49.5	FAIR CONDITION, SOME DIEBACK NOTED - TO BE REMOVED

GENERAL NOTE:

1. LANDSCAPING IS PROVIDED IN ACCORDANCE WITH SECTION 16.124 OF THE HOWARD COUNTY CODE AND THE LANDSCAPE MANUAL. A FINANCIAL SURETY IN THE AMOUNT OF \$10,350.00 FOR THE REQUIRED 21 SHADE TREES, 6 SHADE REPLACEMENT SPECIMEN TREES AND 15 EVERGREEN TREES SHALL BE POSTED WITH THE FINAL PLAN DEVELOPERS AGREEMENT.

SCHEDULE 'A' PERIMETER LANDSCAPE EDGE

CATEGORY	ADJACENT TO ROADWAYS	ADJACENT TO PERIMETER PROPERTIES	TOTAL
PERIMETER/FRONTAGE DESIGNATION	2	3	5
LANDSCAPE TYPE	A	B	A
LINEAR FEET OF ROADWAY FRONTAGE/PERIMETER	166'	339'	1261'
CREDIT FOR EXISTING VEGETATION (YES, NO, LINEAR FEET DESCRIBE BELOW IF NEEDED)	YES	YES	YES
CREDIT FOR WALL, FENCE OR BERM (YES, NO, LINEAR FEET DESCRIBE BELOW IF NEEDED)	NO	NO	NO
NUMBER OF PLANTS REQUIRED	1-60	2	1-60
SHADE TREES	2	1-60	5
EVERGREEN TREES	1	1-60	12
SHRUBS	1	1-60	3
NUMBER OF PLANTS PROVIDED	2	5	12
SHADE TREES	2	5	15
EVERGREEN TREES	1	1	3
OTHER TREES (2:1 SUBSTITUTION)	1	1	1
SHRUBS (10:1 SUBSTITUTION)	1	1	1
DESCRIBE PLANT SUBSTITUTION CREDITS BELOW IF NEEDED			

LANDSCAPE SCHEDULE NOTE:

1. ALL PLANT MATERIALS SHALL BE FULL AND HEAVY, BE WELL FORMED AND SYMMETRICAL, CONFORM TO THE MOST CURRENT AN SPECIFICATIONS AND BE INSTALLED IN ACCORDANCE WITH HED PLANTING SPECIFICATIONS.
2. CONTRACTOR SHALL VERIFY LOCATION OF ALL UNDERGROUND UTILITIES PRIOR TO DIGGING.
3. FINAL LOCATION OF PLANT MATERIAL MAY NEED TO VARY TO MEET FINAL FIELD CONDITIONS. TREES SHALL NOT BE PLANTED IN THE BOTTOM OF DRAINAGE SWALES.
4. CONTRACTOR SHALL VERIFY PLANT QUANTITIES PRIOR TO BIDDING. IF PLAN DIFFERS FROM LANDSCAPE SCHEDULE, THE PLAN SHALL GOVERN.


SPECIMEN TREE - REPLACEMENT CALCULATIONS

NO. TO BE REMOVED	NO. REPLACEMENT REQUIRED	NO. PROVIDED
3	6 NATIVE	6
		3" CALIPER REQ.

SEE WP-20-036 NOTE 4.3, SHEET 1.
FUTURE FINAL PLAN SHALL PROVIDE LOCATIONS AND SPECIES


STREET TREE CALCULATIONS

STREET NAME	LINEAR FEET	NO. REQUIRED	NO. PROVIDED
GREEN DRAKE ROAD	910/40	46	46

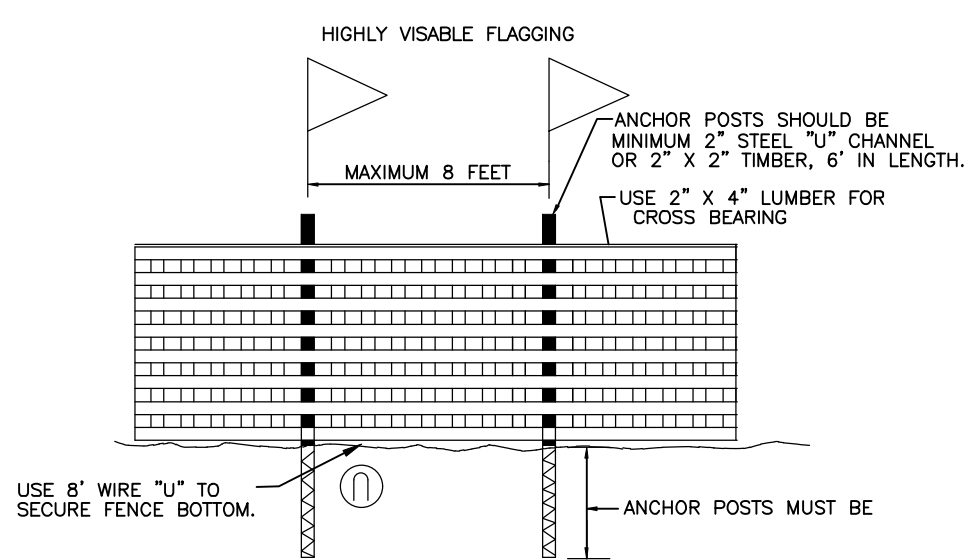

- NOTES:**
1. FOREST PROTECTION DEVICE ONLY.
 2. RETENTION AREA WILL BE SET AS PART OF THE REVIEW PROCESS.
 3. BOUNDARIES OF RETENTION AREA SHOULD BE STAKED AND FLAGGED PRIOR TO INSTALLING DEVICE.
 4. ROOT DAMAGE SHOULD BE AVOIDED.
 5. REFER TO HOWARD COUNTY STANDARD DETAIL L-9-02.

BLAZE ORANGE PLASTIC MESH TYPICAL TREE PROTECTION FENCE DETAIL

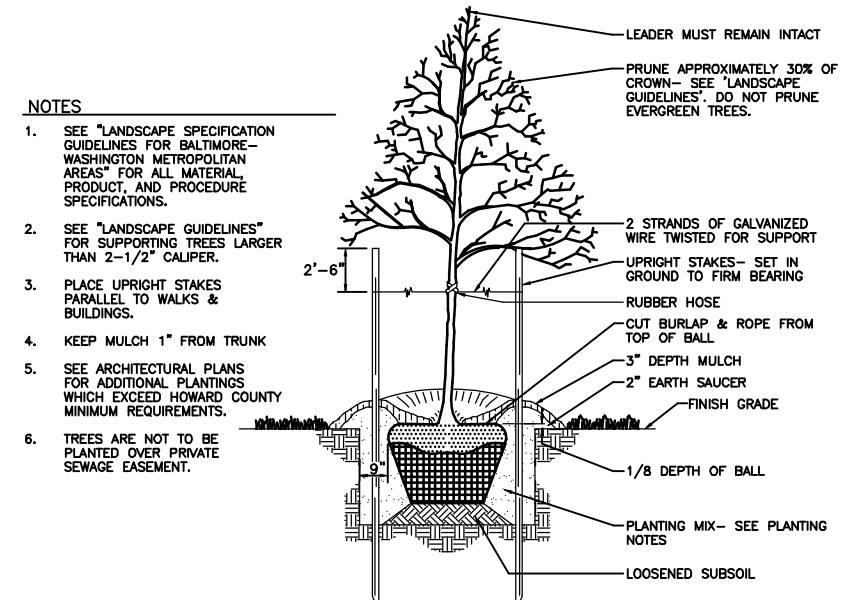


TREE PLANTING AND STAKING

DECIDUOUS TREES UP TO 2-1/2" CALIPER NOT TO SCALE

TENTATIVELY APPROVED DEPARTMENT OF PLANNING AND ZONING HOWARD COUNTY

PLANNING DIRECTOR DATE

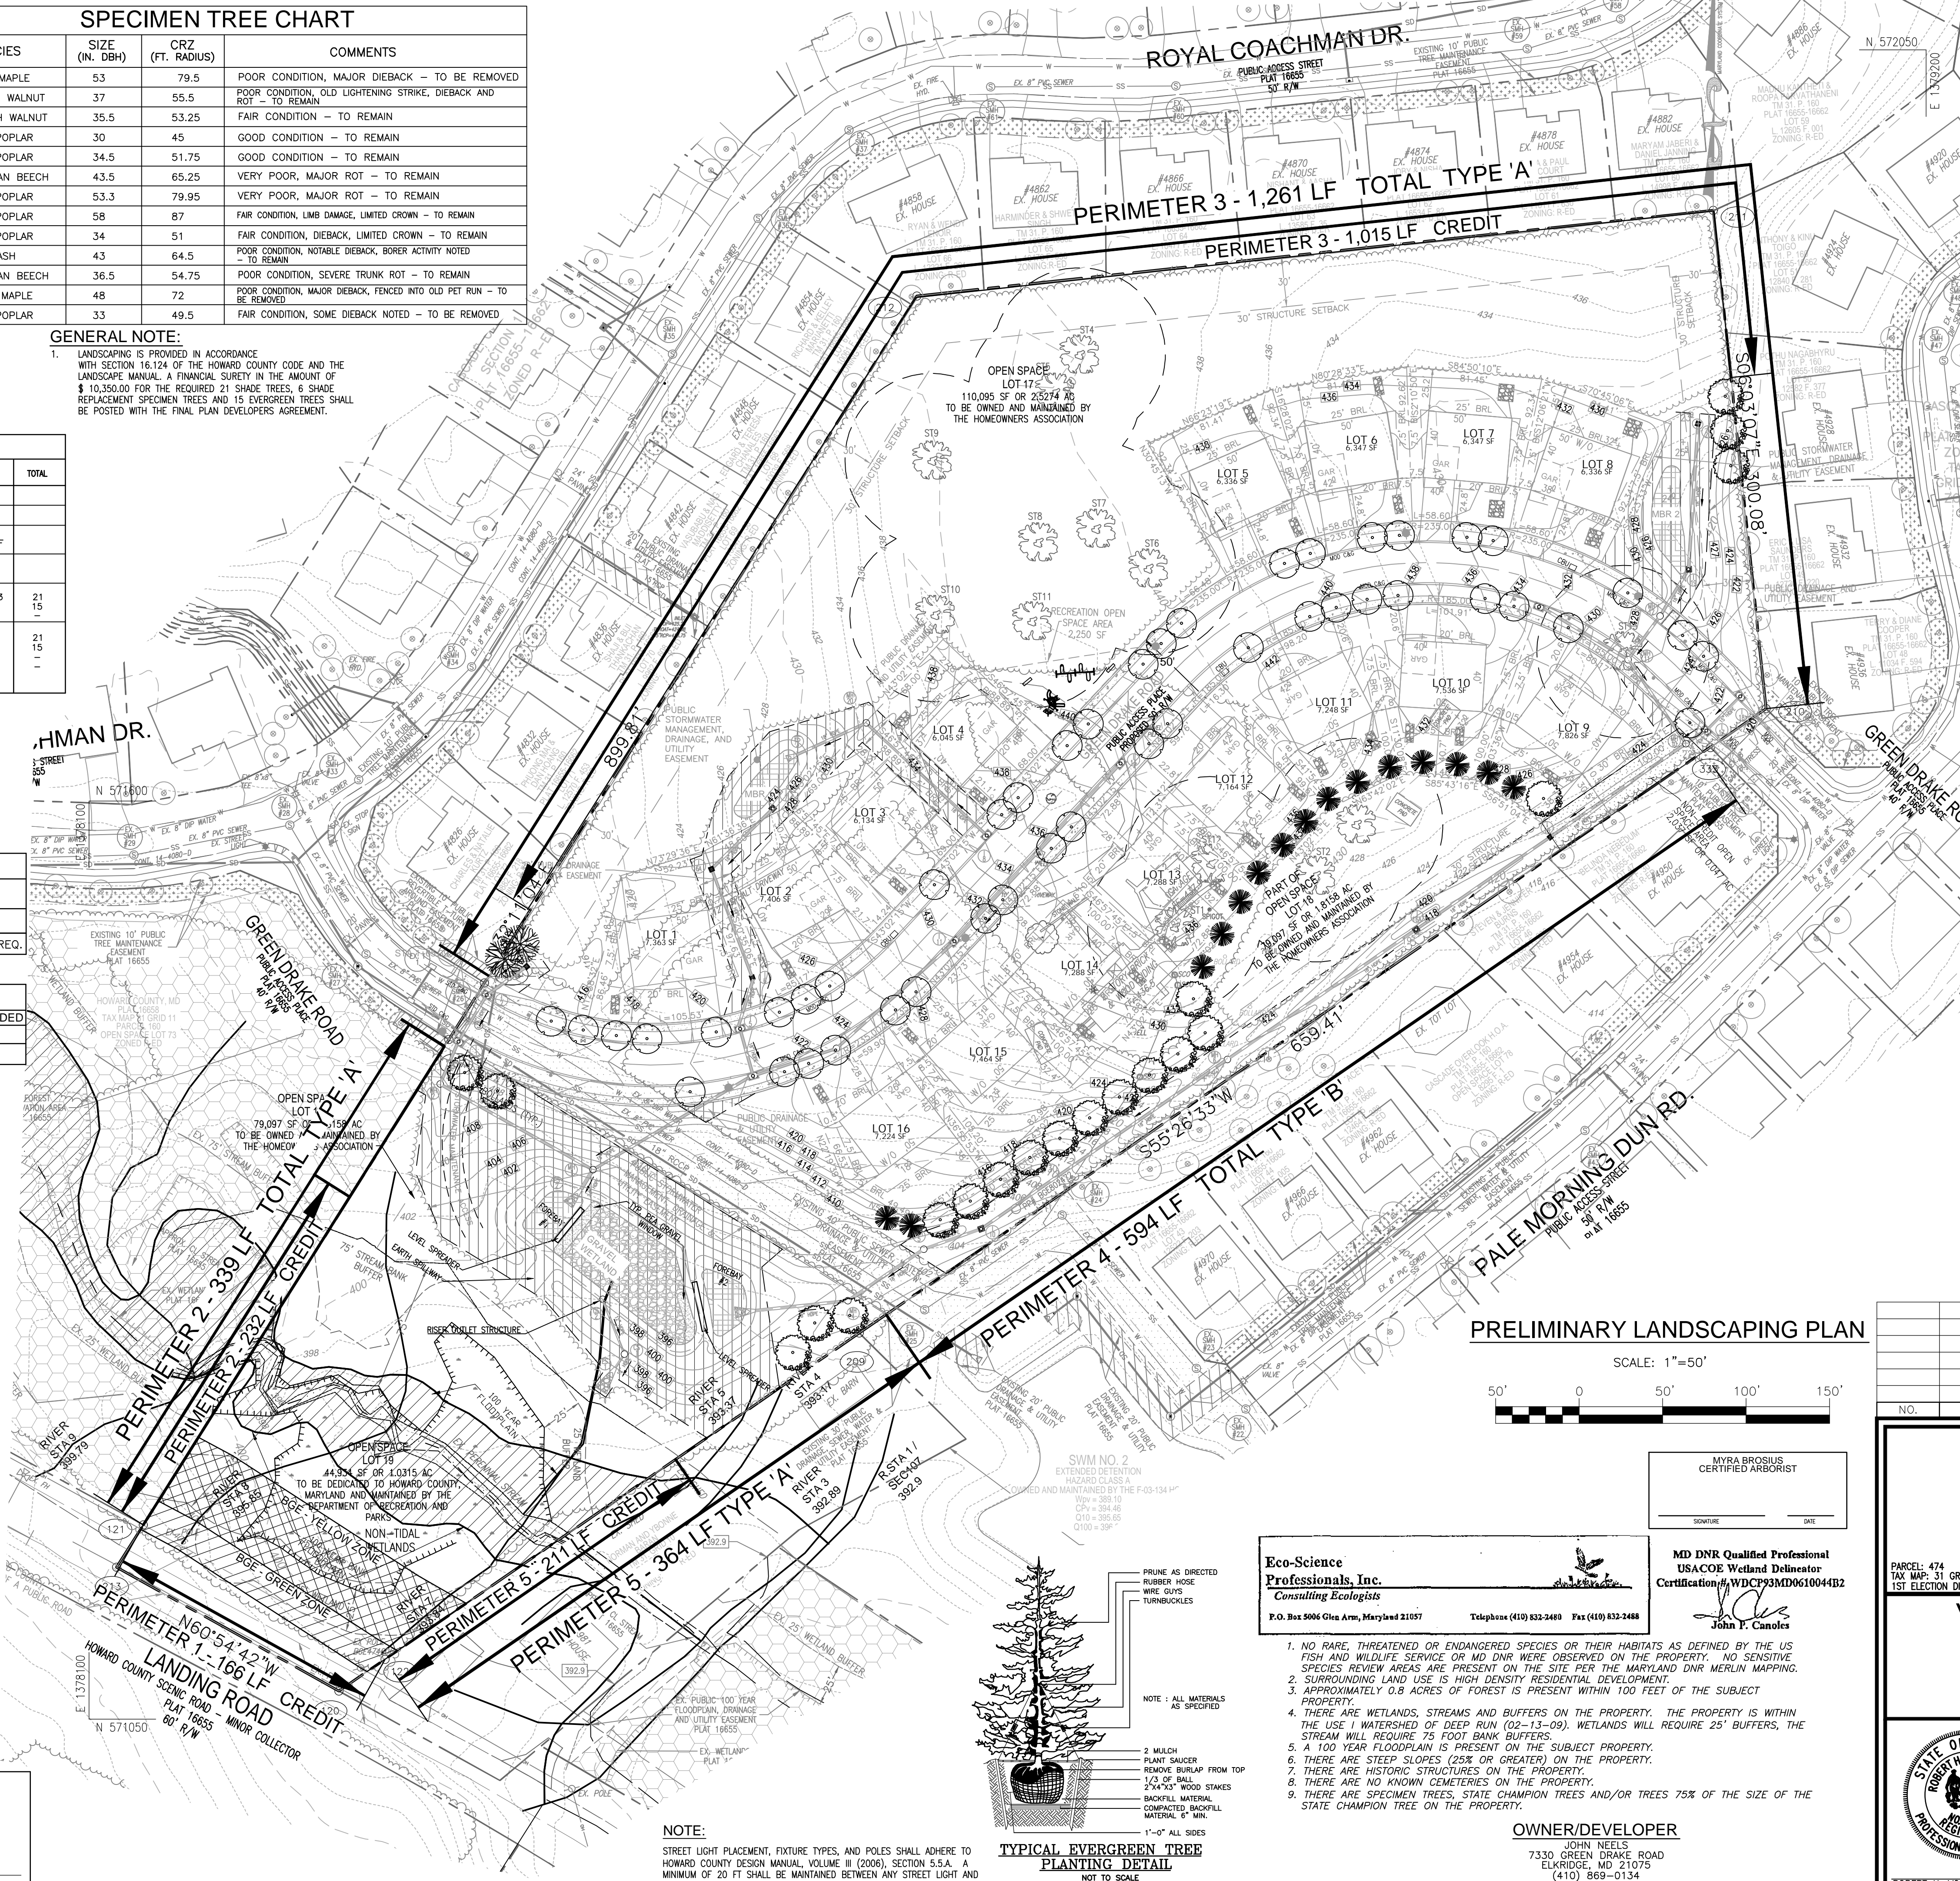

LEGEND:

- PROPERTY LINE
- RIGHT-OF-WAY LINE
- ADJACENT PROPERTY LINE
- EXISTING PAVING
- EXISTING UTILITY POLE
- EXISTING SANITARY MANHOLE
- EXISTING SANITARY LINE
- EXISTING FIRE HYDRANT
- EXISTING WATER LINE
- EXISTING 1' CONTOUR
- EXISTING 2' CONTOUR
- EXISTING TREELINE
- CENTERLINE OF EXISTING STREAM
- EXISTING WETLANDS
- EXISTING WETLAND BUFFER
- EX. PUBLIC 100-YEAR FLOOD PLAN
- EXISTING FOREST CONSERVATION EASEMENT (PLAT 16655)
- PROPOSED TREELINE
- EXISTING SPECIMEN TREE
- EXISTING LANDSCAPING UNDER F-03-134
- PERIMETER OR STREET TREE PLANTING OBLIGATION
- PERIMETER 3 LANDSCAPE PERIMETER
- BGE GREEN ZONE
- BGE YELLOW ZONE

DPZ'S POLICIES GOVERNING THE PLACEMENT OF LANDSCAPING AND STREET TREES IN PROXIMITY TO BGE'S POWER LINES OR TRANSMISSION RIGHT-OF-WAY ARE BASED ON BGE'S PUBLISHED "PLANTING ZONE CONCEPT" WHICH STIPULATES THE MAXIMUM ALLOWABLE SIZE OF PLANT MATERIALS FOR THREE DEFINED ZONES. AS THE DISTANCE FROM BGE EQUIPMENT INCREASES, SO DOES THE SIZE OF THE ALLOWABLE PLANT MATERIALS. THESE THREE ZONES ARE DEFINED AS FOLLOWS:

ZONE	DISTANCE FROM THE BGE POWER LINE OR TRANSMISSION RIGHT-OF-WAY	MAXIMUM HEIGHT OF VEGETATION
GREEN	UP TO 20 FEET	25 FEET
YELLOW	BETWEEN 20 FEET AND 45 FEET	40 FEET
BGE	BEYOND 45 FEET	ABOVE 40 FEET

- B & E NOTES:**
1. BGE RESERVES THE RIGHT TO TRIM, TOP OR CUT DOWN ANY TREE IN PROXIMITY TO THE LINE THAT IN THE OPINION OF BGE SHALL BE DEEMED A HAZARD TO THE SAFETY AND RELIABLE DELIVERY OF ELECTRICITY.
 2. THE DEPARTMENT OF PLANNING AND ZONING MAY AUTHORIZE THE TRIMMING OR REMOVAL OF TREES OR VEGETATION IMMEDIATELY ADJACENT TO THE BGE R/W OR EXPOSURE, IF BGE DETERMINES THE TREES ARE COMPROMISING THE SAFETY OF A TRANSMISSION LINE LOCATED WITHIN THEIR UTILITY R/W OR EXPOSURE. IF BGE INTENDS TO TRIM OR REMOVE TREES WITHIN A FOREST CONSERVATION EASEMENT, A LETTER SPECIFYING THE LOCATION AND SCOPE OF WORK NEEDS TO BE SENT TO DPZ AT LEAST 30 DAYS IN ADVANCE OF UNDERTAKING THE WORK. DPZ UNDERSTANDS CONSULTATION ENGINEER'S NEED TO PROTECT ITS TRANSMISSION LINES AND WILL NOT UNREASONABLY WITHHOLD PERMISSION.
 3. CALL BGE UTILITY TO MARK UP THE LOCATION OF EXISTING GAS LINE BEFORE PLANTING STREET TREES ALONG LANDING ROAD & PLANT STREET TREES 10' AWAY FROM EXISTING GASLINE AS REQUIRED.

- NOTE:**
1. IN THE DIRECTION FACING A TRAFFIC CONTROL SIGN:
 - 1) THERE SHALL BE A MINIMUM OF 40' BETWEEN THE SIGN FACE AND CLOSEST TREE FOR ALL STOP SIGNS.
 - 2) THERE SHALL BE A MINIMUM OF 35' BETWEEN THE SIGN FACE AND CLOSEST TREE FOR ALL SIGNS OTHER THAN A STOP SIGN.
 - 3) A MINIMUM CLEARING OF 20' SHALL BE MAINTAINED BETWEEN ANY STREET LIGHT AND ANY TREE.

Eco-Science Professionals, Inc.
Consulting Ecologists
P.O. Box 5006 Oles Arm, Maryland 21057 Telephone (410) 832-2468 Fax (410) 832-2468

MD DNR Qualified Professional USACOE Wetland Delineator
Certification # WDCP93MD061004482
John J. Canoles

1. NO RARE, THREATENED OR ENDANGERED SPECIES OR THEIR HABITATS AS DEFINED BY THE US FISH AND WILDLIFE SERVICE OR MD DNR WERE OBSERVED ON THE PROPERTY. NO SENSITIVE SPECIES REVIEW AREAS ARE PRESENT ON THE SITE PER THE MARYLAND DNR MERLIN MAPPING.
2. SURROUNDING LAND USE IS HIGH DENSITY RESIDENTIAL DEVELOPMENT.
3. APPROXIMATELY 0.8 ACRES OF FOREST IS PRESENT WITHIN 100 FEET OF THE SUBJECT PROPERTY.
4. THERE ARE WETLANDS, STREAMS AND BUFFERS ON THE PROPERTY. THE PROPERTY IS WITHIN THE USE 1 WATERSHED OF DEEP RUN (02-13-09). WETLANDS WILL REQUIRE 25' BUFFERS, THE STREAM WILL REQUIRE 75 FOOT BANK BUFFERS.
5. A 100 YEAR FLOODPLAIN IS PRESENT ON THE SUBJECT PROPERTY.
6. THERE ARE STEEP SLOPES (25% OR GREATER) ON THE PROPERTY.
7. THERE ARE HISTORIC STRUCTURES ON THE PROPERTY.
8. THERE ARE NO KNOWN CEMETERIES ON THE PROPERTY.
9. THERE ARE SPECIMEN TREES, STATE CHAMPION TREES AND/OR TREES 75% OF THE SIZE OF THE STATE CHAMPION TREE ON THE PROPERTY.

OWNER/DEVELOPER
JOHN NEEDS
7330 GREEN DRAKE ROAD
ELKDRIDGE, MD 21075
(410) 869-0134

NO.	REVISION	DATE

PRELIMINARY EQUIVALENT SKETCH PLAN
PRELIMINARY LANDSCAPING PLAN
CASCADE RIDGE
LOTS 1-16 AND OPEN SPACE LOTS 17 - 19
7330 GREEN DRAKE ROAD
ELKDRIDGE, MD 21075

VOGEL ENGINEERING
TIMMONS GROUP
3300 NORTH RIDGE ROAD, SUITE 110, ELLICOTT CITY, MD 21043
P: 410.461.7666 F: 410.461.8961 www.timmons.com

STATE OF MARYLAND
ROBERT HARRIS
PROFESSIONAL ENGINEER

DESIGN BY: RHV
DRAWN BY: MDL, VTH
CHECKED BY: RHV
DATE: JANUARY 2020
SCALE: AS SHOWN
W.O. NO.: 42148

I HEREBY CERTIFY THAT THESE DOCUMENTS WERE PREPARED OR APPROVED BY ME AND THAT I AM A DEX LICENSED PROFESSIONAL ENGINEER UNDER THE LAWS OF THE STATE OF MARYLAND, LICENSE NO. 16193 EXPIRATION DATE: 09-27-2022

PROFESSIONAL CERTIFICATE

7 SHEET OF 10

FOREST CONSERVATION AREA SIGNS

SPECIMEN TREE

DO NOT REMOVE

MACHINERY, DUMPING OR STORAGE OF ANY MATERIALS IS PROHIBITED

VIOLATORS ARE SUBJECT TO FINES AS IMPOSED BY THE MARYLAND FOREST CONSERVATION ACT OF 1991

FOREST RETENTION AREA

DO NOT DISTURB

MACHINERY, DUMPING OR STORAGE OF ANY MATERIALS IS PROHIBITED

VIOLATORS ARE SUBJECT TO FINES AS IMPOSED BY THE MARYLAND FOREST CONSERVATION ACT OF 1991

FOREST CONSERVATION LEGEND

PROPOSED FOREST CONSERVATION EASEMENT RETENTION (CREDITED)


PROPOSED FOREST CONSERVATION EASEMENT RETENTION (NON-CREDITED)

EXISTING FOREST CONSERVATION EASEMENT (PLAT #16655)

- NOTE:**
1. BOTTOM OF SIGNS TO BE HIGHER THAN TOP OF TREE PROTECTION FENCE.
 2. SIGNS TO BE PLACED APPROXIMATELY 50-100' FEET APART. CONDITIONS ON SITE AFFECTING VISIBILITY MAY WARRANT PLACING SIGNS CLOSER OR FARTHER APART. WHERE SIGNS ARE TO BE PLACED AT THE REAR OF PROPOSED LOTS, SPACING SHALL BE APPROX. 25'-30'.
 3. ATTACHMENT OF SIGNS TO TREES IS PROHIBITED.
 4. ALL FOREST CONSERVATION SIGNAGE SHALL BE IN PLACE FOR PERPETUITY.
 5. SIGN LOCATION SYMBOL = ●

EASEMENT	RETENTION		REFORESTATION	TOTAL
	CREDITED	NON-CREDITED		
FCE#1	0.87 AC	0.27 AC	0 AC	1.14 AC
FCE#2	2.12 AC	0 AC	0 AC	2.12 AC
FCE#3	0.30 AC	0 AC	0 AC	0.30 AC
BANK *	0.00 AC	0 AC	0.70 AC	0.70 AC
TOTAL	3.29 AC	0.27 AC	0.70 AC	4.26 AC

* ABOVE 0.7 AC BANK PURCHASE SHALL OCCUR WITHIN THE PROJECTS WATERSHED

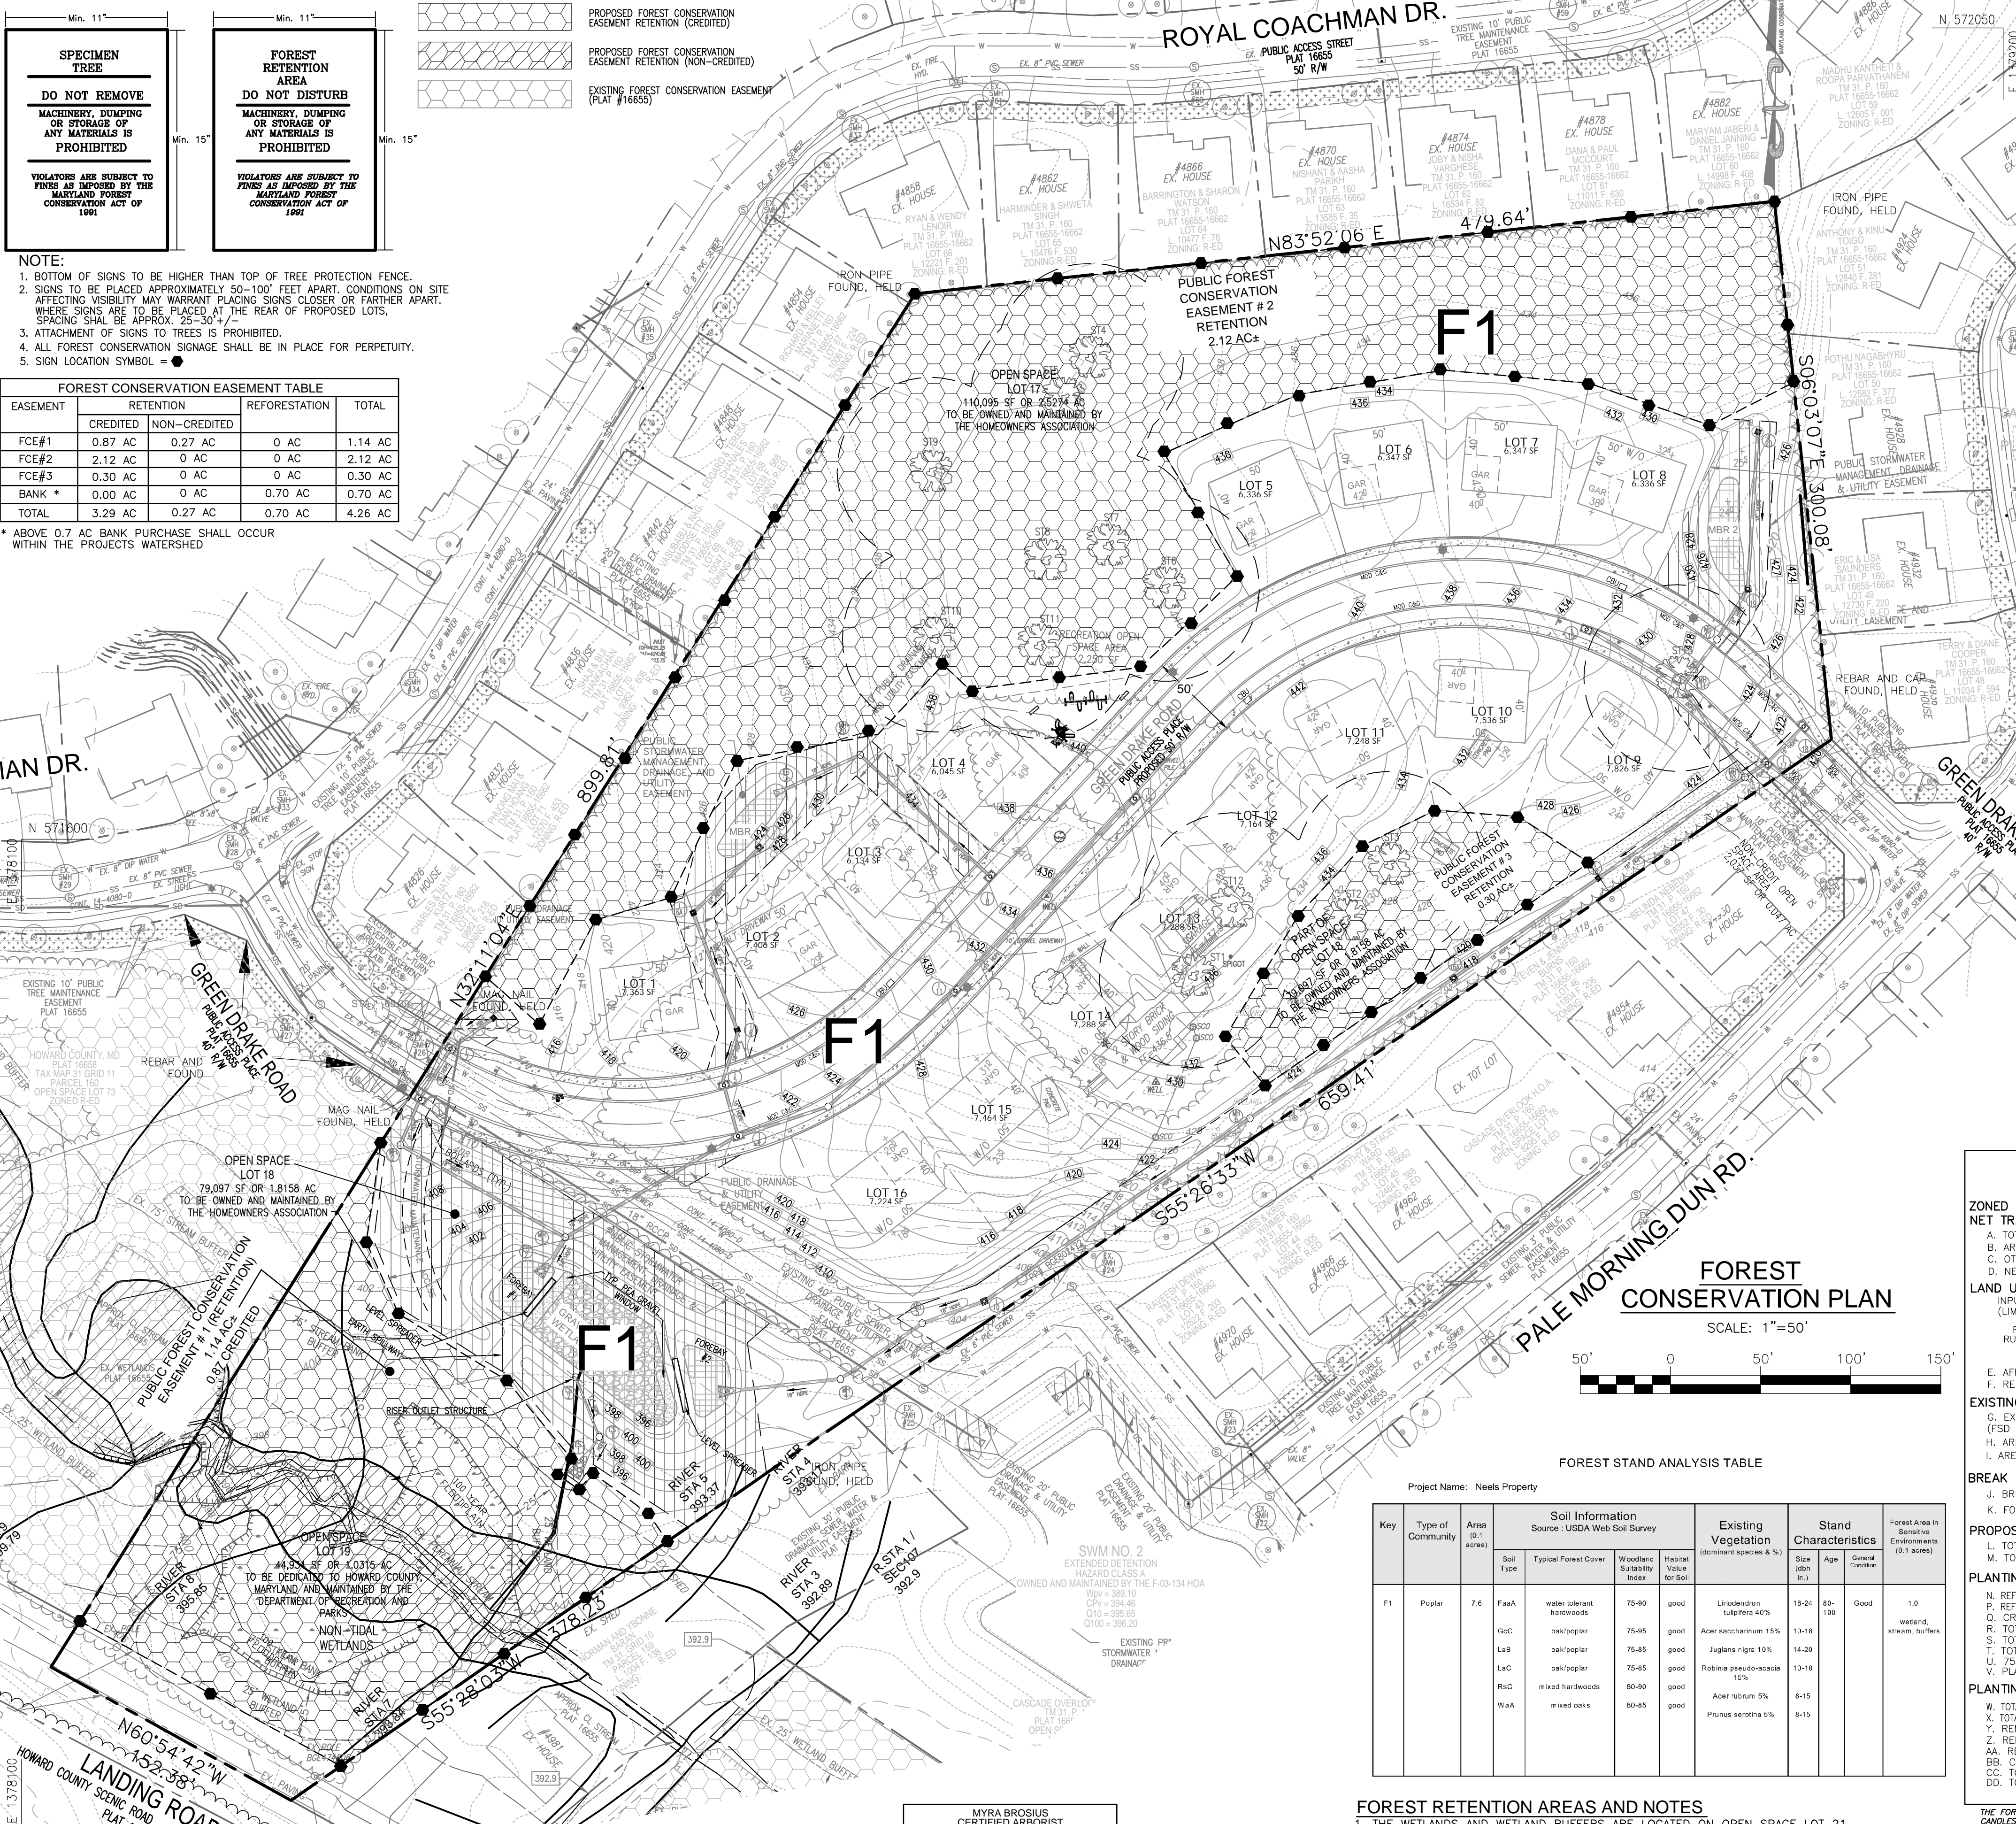


FOREST CONSERVATION PLAN

SCALE: 1"=50'

Project Name: Neels Property

Key	Type of Community	Area (± acres)	Soil Information Source: USDA Web Soil Survey	Existing Vegetation (dominant species & %)	Stand Characteristics (Size (dbh), Age, Growth)	Forest Area in Sensitive Environments (± acres)
F1	Poplar	7.6	FaAa water tolerant subsoils	75-90 good Liriodendron tulipifera 40% Acer saccharinum 15% Juglans nigra 10% Robinia pseudo-acacia 15%	18-24 80-100 Good	1.0 wetland, stream, buffers

- FOREST RETENTION AREAS AND NOTES**
1. THE WETLANDS AND WETLAND BUFFERS ARE LOCATED ON OPEN SPACE LOT 21.
 2. NO RARE, THREATENED OR ENDANGERED SPECIES OR THEIR HABITATS WERE OBSERVED ON THIS SITE.
 3. FORESTED AREAS ADJACENT TO FLOODPLAINS AND STREAM BUFFERS ARE SUBSTANTIALLY RETAINED IN OPEN SPACE LOTS.
 4. CHANGES IN GRADING AND RUNOFF WITHIN CONSTRUCTION/INSTALLATION AREAS WILL NOT ADVERSELY AFFECT THE SOILS WITHIN THE FOREST RETENTION AREA. SEDIMENT CONTROL MEASURES WILL REDIRECT CONCENTRATED FLOW RUNOFF TO STORMWATER MANAGEMENT FACILITIES. RETAIN SEDIMENT WITHIN THE CONSTRUCTION SITE, AND/OR REDIRECT CLEAN WATER AWAY FROM CONSTRUCTION AREAS.
 5. THE FOREST CONSERVATION EASEMENT HAS BEEN ESTABLISHED TO FULFILL THE REQUIREMENTS OF SECTION 16.1200 OF THE HOWARD COUNTY SUBDIVISION AND LAND DEVELOPMENT REGULATIONS AND THE FOREST CONSERVATION MANUAL. NO CLEARING, GRADING OR CONSTRUCTION IS PERMITTED WITHIN THE FOREST CONSERVATION EASEMENT, HOWEVER, FOREST MANAGEMENT PRACTICES AS DEFINED IN THE DEED OF FOREST CONSERVATION EASEMENT ARE ALLOWED.

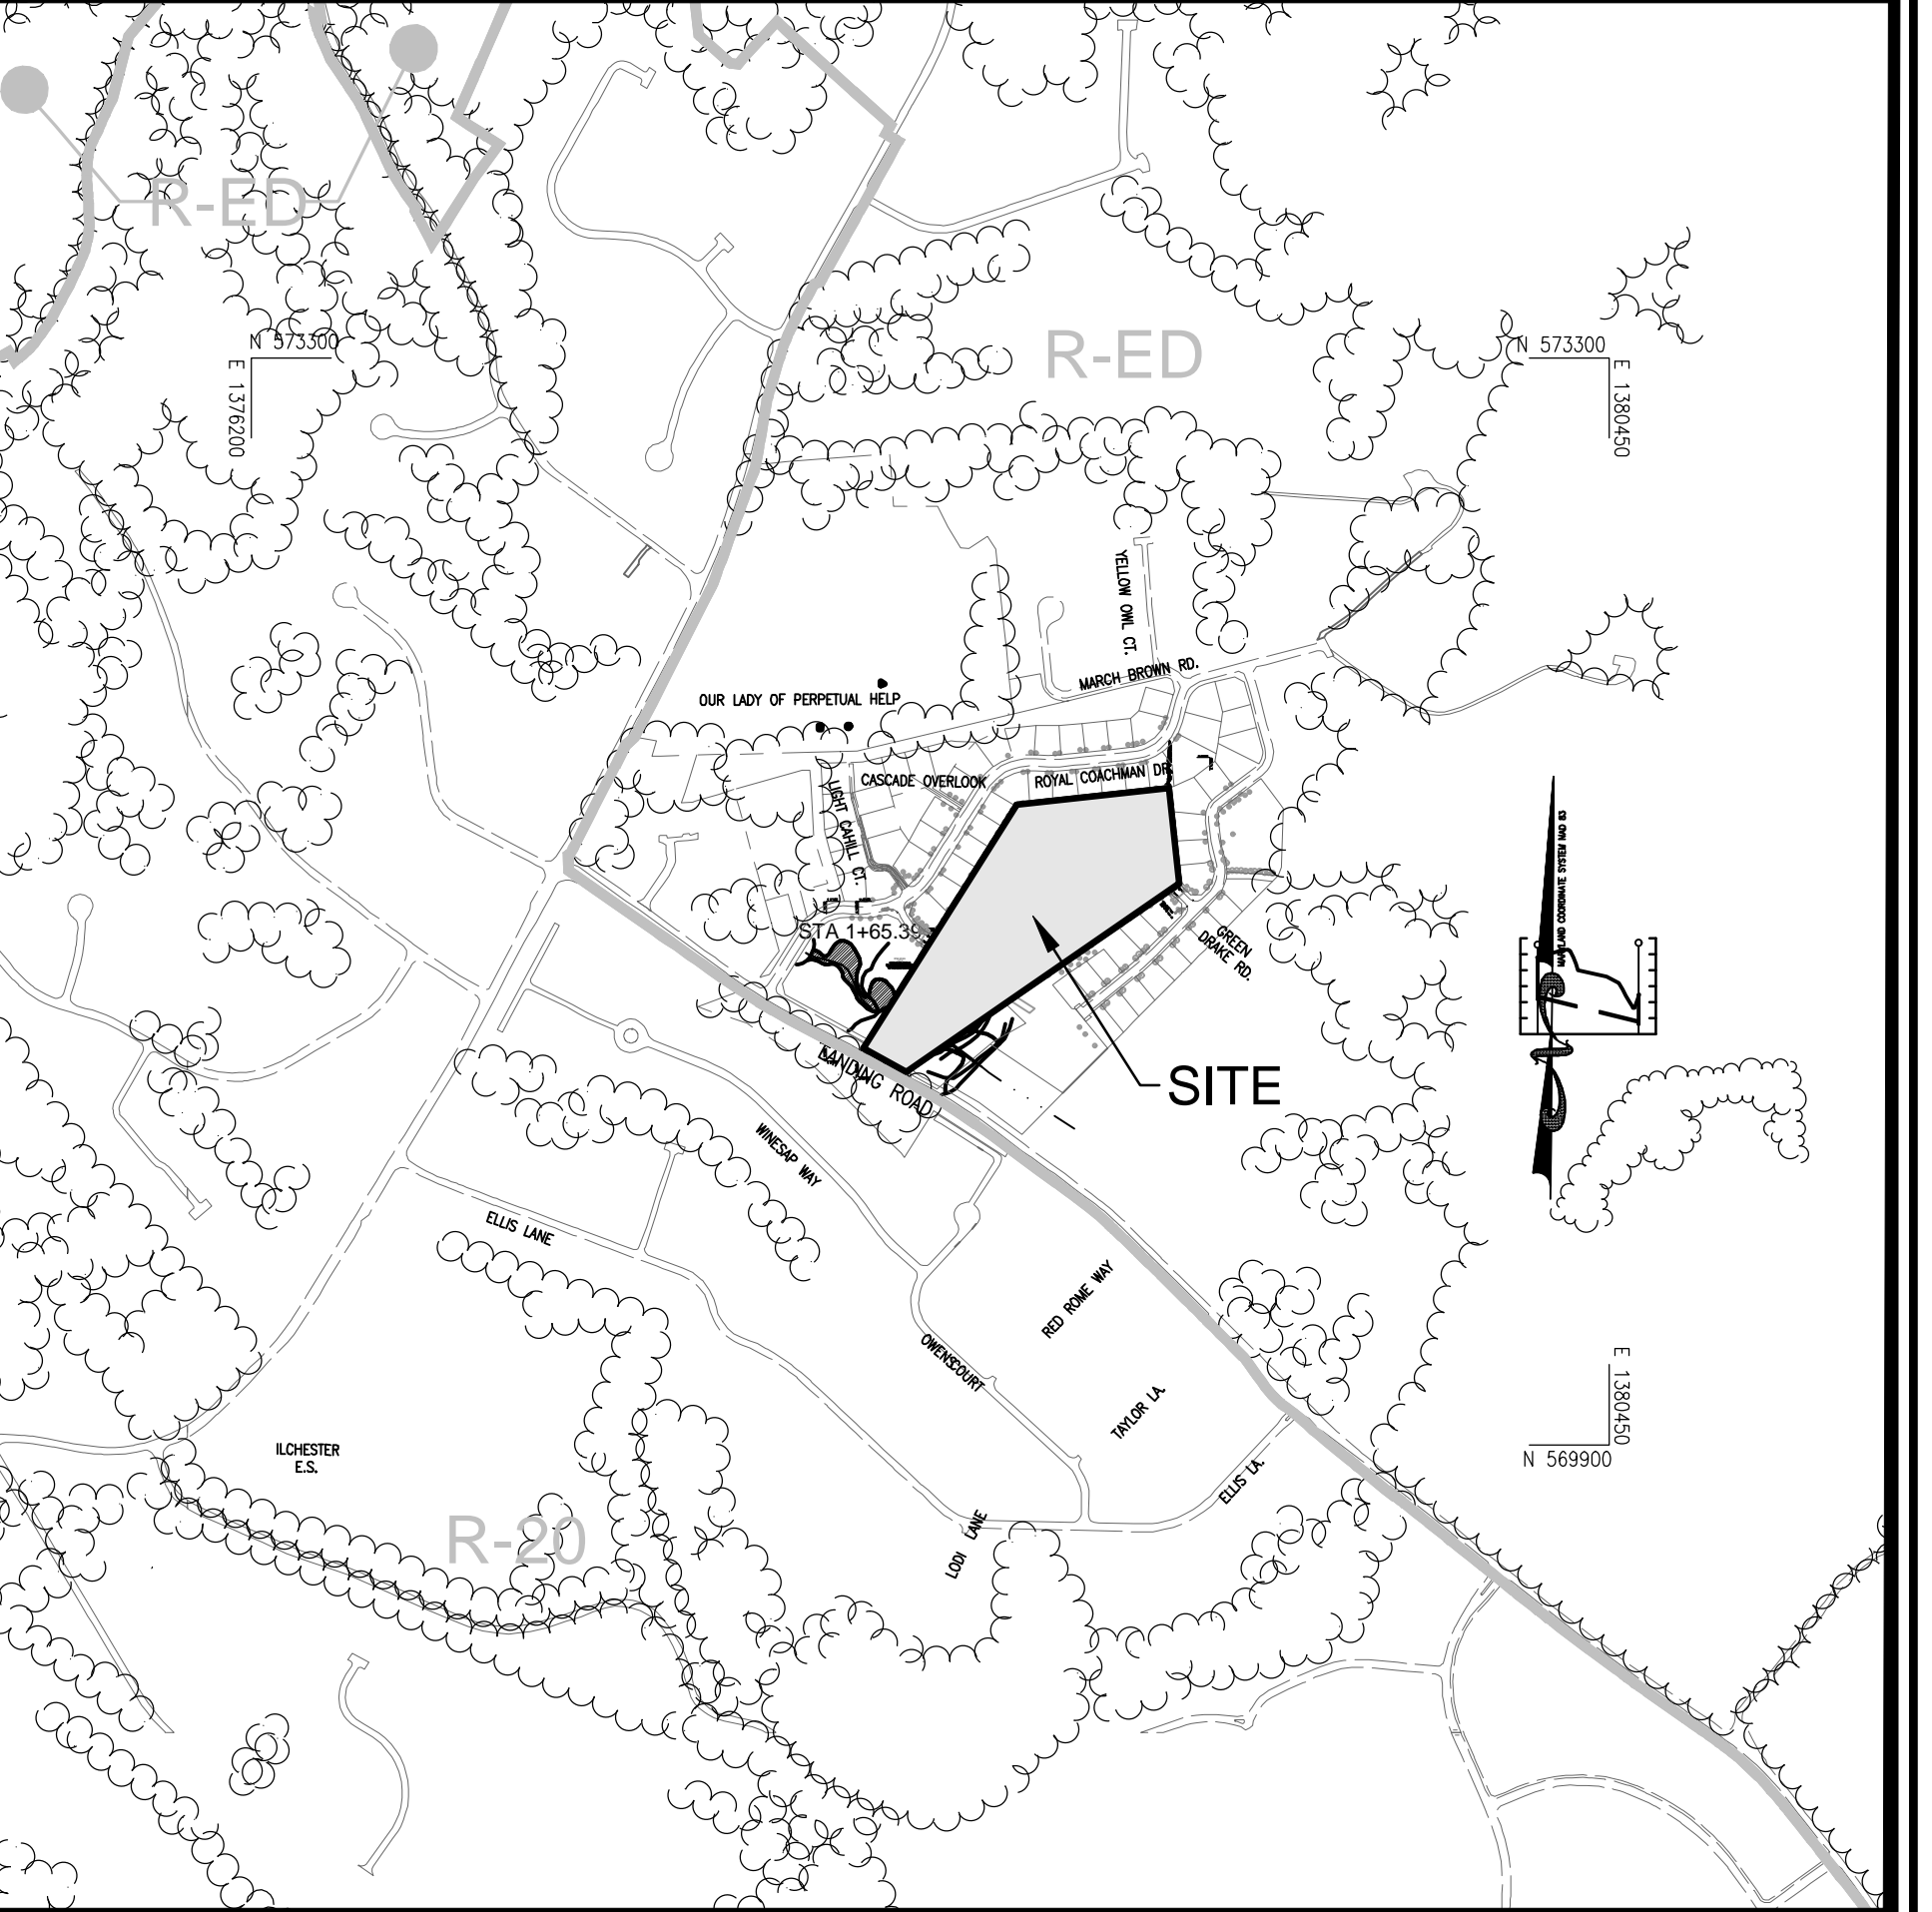

LOCATION MAP

SCALE: 1"=600'

ADC MAP COORDINATE: PAGE: 28, 5-E

GENERAL NOTES

- WATERSHED NAME: USE 1 WATERSHED DEEP RUN (02-13-09)
- GROSS SITE AREA: 9.09 AC.
 - NET SITE AREA: 9.09 AC.
 - AREA OF 100-YEAR FLOODPLAIN: 0.30 AC.
 - AREA OF WETLANDS AND BUFFERS: 0.82 AC.
 - AREA OF > 15% STEEP SLOPES: 1.10 AC.
 - EXISTING FOREST WITHIN NET AREA: 7.6 AC.
- F. ZONED: RESIDENTIAL
- G. EXISTING USE: RESIDENTIAL
- H. PROPOSED USE: RESIDENTIAL

LEGEND:

- PROFFER LINE
- RIGHT-OF-WAY LINE
- ADJACENT PROPERTY LINE
- EXISTING PAVING
- EXISTING UTILITY POLE
- EXISTING SANITARY MANHOLE
- EXISTING SANITARY LINE
- EXISTING FIRE HYDRANT
- EXISTING WATER LINE
- EXISTING 10' CONTOUR
- EXISTING 2' CONTOUR
- EXISTING TREENLINE
- CENTERLINE OF EXISTING STREAM
- EXISTING WETLANDS
- EXISTING WETLAND BUFFER
- EX. PUBLIC 100-YEAR FLOOD PLAN

HOWARD COUNTY CASCADE RIDGE
FOREST CONSERVATION WORKSHEET

ZONED R-ED

NET TRACT AREA:

A. TOTAL GROSS TRACT AREA	A = 9.1 AC
B. AREA WITHIN 100 YEAR FLOODPLAIN	B = 0.3 AC
C. OTHER DEDUCTIONS (IDENTIFY)	C = 0.0 AC
D. NET TRACT AREA	D = 8.8 AC

LAND USE CATEGORY:

INPUT THE NUMBER "1" UNDER THE APPROPRIATE LAND USE (LIMIT TO ONLY ONE ENTRY): ZONED R-ED

RESID.	RESID.	INST./	RETAIL/IND./	MIXED USE/
0	0	0	0	0
RURAL LD	RURAL MD	SUBURBAN	LINEAR	
0	0	0	0	0

E. AFFORESTATION THRESHOLD _____ NET TRACT AREA X 15% = E = 1.3 AC

F. REFORESTATION THRESHOLD _____ NET TRACT AREA X 20% = F = 1.8 AC

EXISTING FOREST COVER:

G. EXISTING FOREST COVER WITHIN THE NET TRACT AREA (FSD REPORT)	G = 7.3 AC
H. AREA OF FOREST ABOVE AFFORESTATION THRESHOLD	H = 6.0 AC
I. AREA OF FOREST ABOVE REFORESTATION THRESHOLD	I = 5.5 AC

BREAK EVEN POINT:

J. BREAK EVEN POINT	J = 3.63AC
K. FOREST CLEARING PERMITTED WITHOUT MITIGATION	K = 3.67AC

PROPOSED FOREST CLEARING:

L. TOTAL AREA OF FOREST TO BE CLEARED	L = 4.1 AC
M. TOTAL AREA OF FOREST TO BE RETAINED	M = 3.2 AC

PLANTING REQUIREMENTS INSIDE WATERSHED:

N. REFORESTATION FOR CLEARING ABOVE THE REFORESTATION THRESHOLD	N = 2.1 AC
P. REFORESTATION FOR CLEARING BELOW THE REFORESTATION THRESHOLD	P = 0.0 AC
Q. CREDIT FOR RETENTION ABOVE REFORESTATION THRESHOLD	Q = 1.4 AC
R. TOTAL REFORESTATION REQUIRED	R = 0.7 AC
S. TOTAL AFFORESTATION REQUIRED	S = 0.0 AC
T. TOTAL REFORESTATION AND AFFORESTATION REQUIREMENT	T = 0.7 AC
U. 75% OF TOTAL OBLIGATION (RETENTION + PLANTING)	U = 2.9 AC
V. PLANTING REQUIRED ONSITE TO MEET 75% OBLIGATION	V = 0.0 AC

PLANTING REQUIREMENTS OUTSIDE WATERSHED:

W. TOTAL PLANTING WITHIN DEVELOPMENT SITE WATERSHED	W = 0.7 AC
X. TOTAL AFFORESTATION REQUIRED	X = 0.0 AC
Y. REMAINING PLANTING WITHIN WATERSHED FOR REFORESTATION CREDIT	Y = 0.7 AC
Z. REFORESTATION FOR CLEARING ABOVE THE REFORESTATION THRESHOLD	Z = 0.0 AC
AA. REFORESTATION FOR CLEARING BELOW THE REFORESTATION THRESHOLD	AA = 0.0 AC
BB. CREDIT FOR RETENTION ABOVE THE REFORESTATION THRESHOLD	BB = 2.9 AC
CC. TOTAL REFORESTATION REQUIRED	CC = 0.0 AC
DD. TOTAL REFORESTATION AND REFORESTATION REQUIREMENT	DD = 0.0 AC

PRELIMINARY EQUIVALENT SKETCH PLAN
FOREST CONSERVATION PLAN

CASCADE RIDGE

LOTS 1-16 AND OPEN SPACE LOTS 17 - 19

7330 GREEN DRAKE ROAD
ELK RIDGE, MD 21075

PARCEL: 474
TAX MAP: 31 GRD: 11
1ST ELECTION DISTRICT

ZONED: R-ED
L 362 / F 260
HOWARD COUNTY, MARYLAND

VOGEL ENGINEERING

TIMMONS GROUP

3300 NORTH RIDGE ROAD, SUITE 110, ELLICOTT CITY, MD 21043
P: 410.461.7666 F: 410.461.8961 www.timmons.com

DESIGN BY: RHV
DRAWN BY: MDL VETG
CHECKED BY: RHV
DATE: JANUARY 2020
SCALE: AS SHOWN
W.O. NO.: 42148

PROFESSIONAL CERTIFICATE

I HEREBY CERTIFY THAT THESE DOCUMENTS WERE PREPARED OR APPROVED BY ME, AND THAT I AM A Duly Licensed Professional Engineer Under the Laws of the State of Maryland, License No. 1693, EXPIRATION DATE: 09-27-2022

8 SHEET OF 10

TENTATIVELY APPROVED
DEPARTMENT OF PLANNING AND ZONING
HOWARD COUNTY

PLANNING DIRECTOR _____ DATE _____


Eco-Science Professionals, Inc.
Consulting Ecologists

P.O. Box 9006 Clco, Arv, Maryland 21057 Telephone (410) 832-2460 Fax (410) 832-2468

MYRA BROSIUS
CERTIFIED ARBORIST

MD DNR Qualified Professional
USACE Wetland Delineator
Certification # WDCP93MD061004482

John P. Canoles

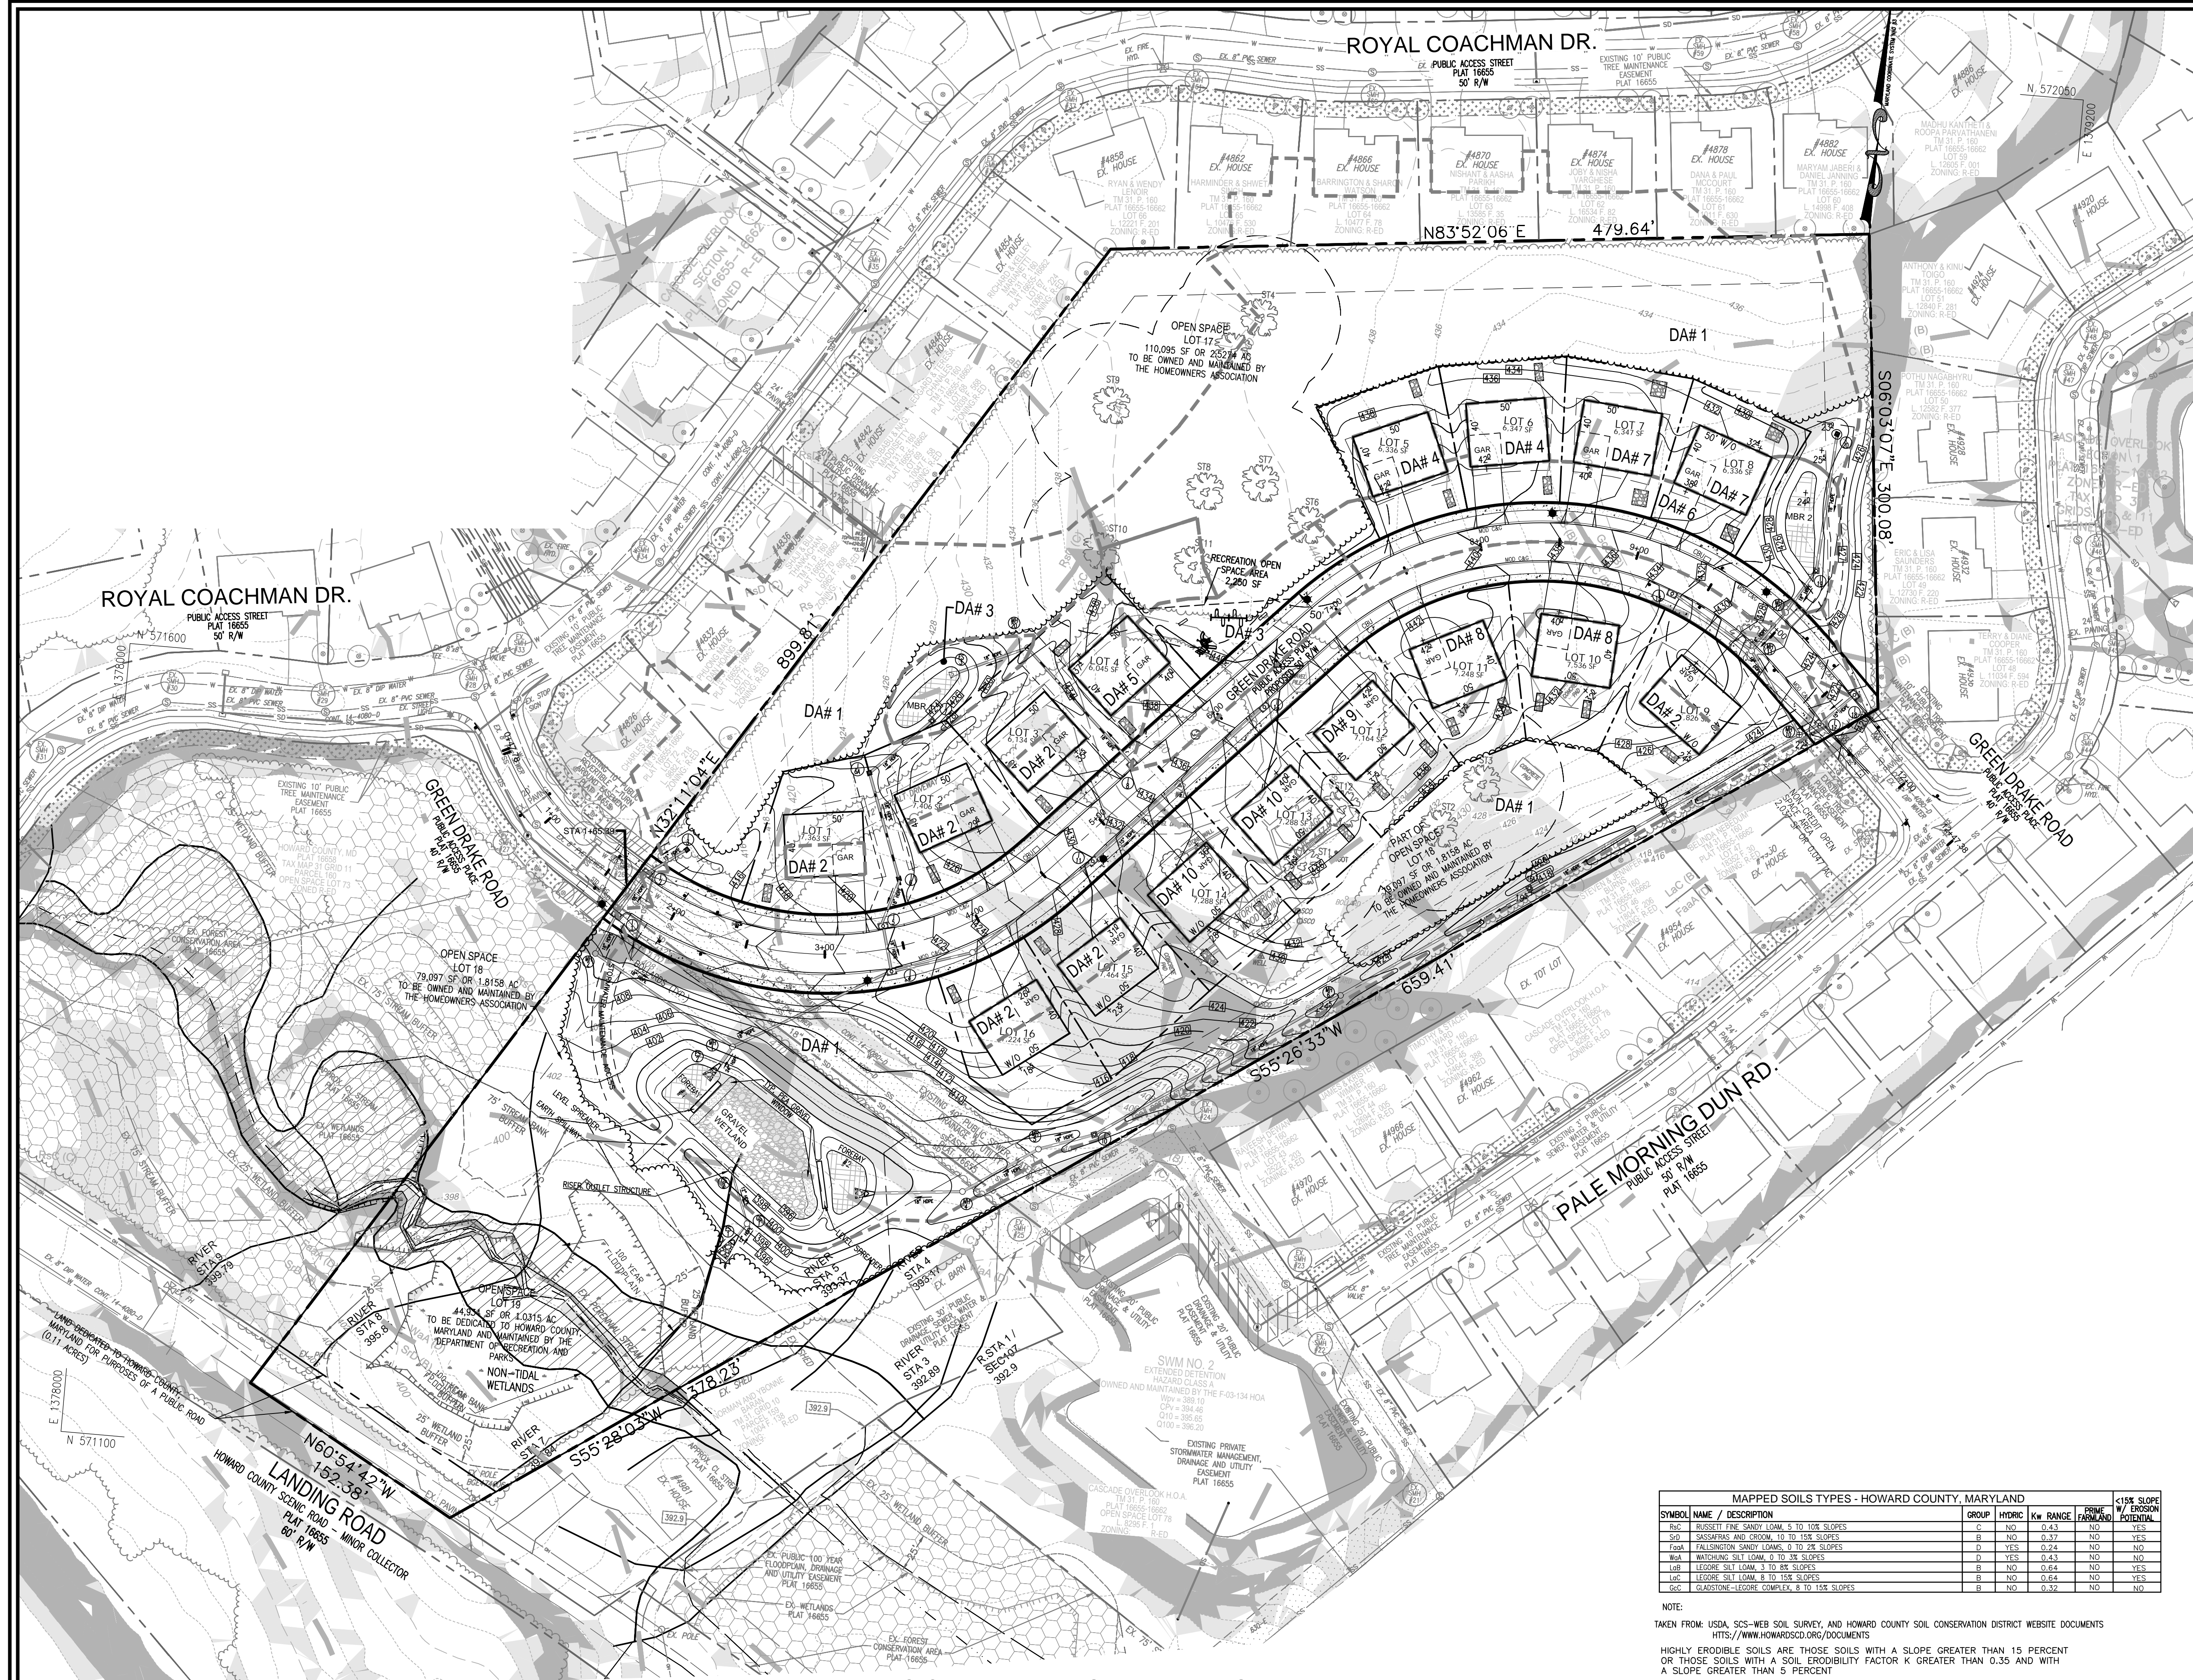

LEGEND:


	PROPERTY LINE
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	EXISTING PAVING
	EXISTING UTILITY POLE
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	EXISTING SANITARY LINE
	EXISTING FIRE HYDRANT
	EXISTING WATER LINE
	EXISTING 10' CONTOUR
	EXISTING 2' CONTOUR
	SOILS
	CENTERLINE OF EXISTING STREAM
	EXISTING SPECIMEN TREE
	EXISTING WETLANDS
	EXISTING WETLAND BUFFER
	EX. PUBLIC 100-YEAR FLOOD PLAN
	EXISTING FOREST CONSERVATION EASEMENT (PLAT 16655)
	PROPOSED STORM DRAIN
	PROPOSED SIDEWALK
	PROPOSED TREE LINE
	PROPOSED CURB
	PROPOSED 10' CONTOUR
	PROPOSED 2' CONTOUR
	DA# 1
	DRAINAGE AREA
	EXISTING PUBLIC SEWER, WATER DRAINAGE & UTILITY EASEMENT (PLAT 16655)

MAPPED SOILS TYPES - HOWARD COUNTY, MARYLAND

SYMBOL	NAME / DESCRIPTION	GROUP	HYDRIC	Kw RANGE	PRIME FARMLAND	15% SLOPE EROSION POTENTIAL
S1p	BUSETT FINE SANDY LOAM, 5 TO 10% SLOPES	S	NO	0.43	NO	YES
S1p	SASSAPARAS AND CROOM, 10 TO 15% SLOPES	B	NO	0.37	NO	YES
T1p	FALSMINGTON SANDY LOAM, 0 TO 2% SLOPES	D	YES	0.24	NO	NO
U1a	BRACKENING SILT LOAM, 0 TO 3% SLOPES	D	YES	0.43	NO	NO
U1b	LEGORE SILT LOAM, 3 TO 8% SLOPES	B	NO	0.64	NO	YES
U1c	LEGORE SILT LOAM, 8 TO 15% SLOPES	B	NO	0.64	NO	YES
U1d	GLADSTONE-LEGORE COMPLEX, 8 TO 15% SLOPES	B	NO	0.32	NO	NO

NOTE:
 TAKEN FROM: USDA, SCS-WEB SOIL SURVEY, AND HOWARD COUNTY SOIL CONSERVATION DISTRICT WEBSITE DOCUMENTS
[HTS://WWW.HOWARDSCD.ORG/DOCUMENTS](https://www.howardscd.org/documents)
 HIGHLY ERODIBLE SOILS ARE THOSE SOILS WITH A SLOPE GREATER THAN 15 PERCENT OR THOSE SOILS WITH A SOIL ERODIBILITY FACTOR K GREATER THAN 0.35 AND WITH A SLOPE GREATER THAN 5 PERCENT

STORMWATER MANAGEMENT DRAINAGE AREA MAP
 SCALE: 1"=50'

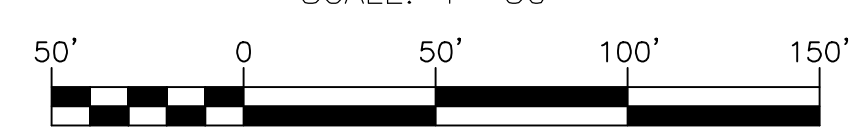

TENTATIVELY APPROVED
 DEPARTMENT OF PLANNING AND ZONING
 HOWARD COUNTY

PLANNING DIRECTOR _____ DATE _____

OWNER/DEVELOPER
 JOHN NEELS
 7330 GREEN DRAKE ROAD
 ELKCRIDGE, MD 21075
 (410) 869-0134

NO.	REVISION	DATE

PRELIMINARY EQUIVALENT SKETCH PLAN
STORMWATER MANAGEMENT DRAINAGE AREA MAP
CASCADE RIDGE
 LOTS 1-16 AND OPEN SPACE LOTS 17 - 19
 7330 GREEN DRAKE ROAD
 ELKCRIDGE, MD 21075

PARCEL: 474
 TAX MAP: 31 GRID: 11
 1ST ELECTION DISTRICT

ZONED: R-ED
 L. 362 / F. 260
 HOWARD COUNTY, MARYLAND

VOGEL ENGINEERING
 TIMMONS GROUP
 3300 NORTH RIDGE ROAD, SUITE 110, ELLICOTT CITY, MD 21043
 P: 410.461.7666 F: 410.461.8961 www.timmons.com

PROFESSIONAL CERTIFICATE
 I HEREBY CERTIFY THAT THESE DOCUMENTS WERE PREPARED OR APPROVED BY ME, AND THAT I AM A FULLY LICENSED PROFESSIONAL ENGINEER UNDER THE LAWS OF THE STATE OF MARYLAND. LICENSE NO. 161893 EXPIRATION DATE: 09-27-2022

DESIGN BY: RHV
 DRAWN BY: MDL VETG
 CHECKED BY: RHV
 DATE: JANUARY 2020
 SCALE: AS SHOWN
 W.O. NO.: 42148

9 SHEET OF 10

APPENDIX B.4.C SPECIFICATIONS FOR MICRO-BIORETENTION. RAIN GARDEN, LANDSCAPE INFILTRATION & INFILTRATION BERMS

1. MATERIAL SPECIFICATIONS

The ALLOWABLE MATERIALS TO BE USED IN THESE PRACTICES ARE DETAILED IN TABLE B.4.1.

2. FILTERING MEDIA OR PLANTING SOIL
THE SOIL SHALL BE A UNIFORM MIX, FREE OF STONES, STUMPS, ROOTS OR OTHER SIMILAR OBJECTS LARGER THAN TWO INCHES.

3. COMPACTION
IT IS VERY IMPORTANT TO MINIMIZE COMPACTION OF BOTH THE BASE OF BIORETENTION PRACTICES AND THE REQUIRED BACKFILL.

4. PLANT MATERIAL
RECOMMENDED PLANT MATERIAL FOR MICRO-BIORETENTION PRACTICES CAN BE FOUND IN APPENDIX A, SECTION A.2.3.

5. PLANT INSTALLATION
COMPOST IS A BETTER ORGANIC MATERIAL SOURCE, IS LESS LIKELY TO FLOAT, AND SHOULD BE PLACED IN THE INVERT AND OTHER LOW AREAS.

6. UNDERDRAINS
UNDERDRAINS SHOULD MEET THE FOLLOWING CRITERIA:
• PIPE - SHOULD BE 4" TO 6" DIAMETER, SLOTTED OR PERFORATED RIGID PLASTIC PIPE (ASTM 758, TYPE PS 28, OR AASHTO-M-278) IN A GRAVEL LAYER.


7. MISCELLANEOUS
THESE PRACTICES MAY NOT BE CONSTRUCTED UNTIL ALL CONTRIBUTING DRAINAGE AREA HAS BEEN STABILIZED.

Table B.4.1 Materials Specifications for Micro-Bioretenion, Rain Gardens & Landscape Infiltration. Columns: Material, Specifications, Size, Notes.

OPERATION AND MAINTENANCE SCHEDULE FOR PRIVATELY OWNED AND MAINTAINED STORMWATER DRY WELLS (M-5)

- 1. THE MONITORING WELLS AND STRUCTURES SHALL BE INSPECTED ON A QUARTERLY BASIS AND AFTER EVERY LARGE STORM EVENT.
2. WATER LEVELS AND SEDIMENT BUILD UP IN THE MONITORING WELLS SHALL BE RECORDED OVER A PERIOD OF SEVERAL DAYS TO INSURE TRENCH DRAINAGE.
3. A LOG BOOK SHALL BE MAINTAINED TO DETERMINE THE RATE AT WHICH THE FACILITY DRAINS.
4. WHEN THE FACILITY BECOMES CLOGGED SO THAT IT DOES NOT DRAIN DOWN WITHIN THE 72 HOUR TIME PERIOD, CORRECTIVE ACTION SHALL BE TAKEN.
5. THE MAINTENANCE LOG BOOK SHALL BE AVAILABLE TO HOWARD COUNTY FOR INSPECTION TO INSURE COMPLIANCE WITH OPERATION AND MAINTENANCE CRITERIA.
6. ONCE THE PERFORMANCE CHARACTERISTICS OF THE INFILTRATION FACILITY HAVE BEEN VERIFIED, THE MONITORING SCHEDULE CAN BE REDUCED TO AN ANNUAL BASIS UNLESS THE PERFORMANCE DATA INDICATES THAT A MORE FREQUENT SCHEDULE IS REQUIRED.


TENTATIVELY APPROVED DEPARTMENT OF PLANNING AND ZONING HOWARD COUNTY. PLANNING DIRECTOR DATE

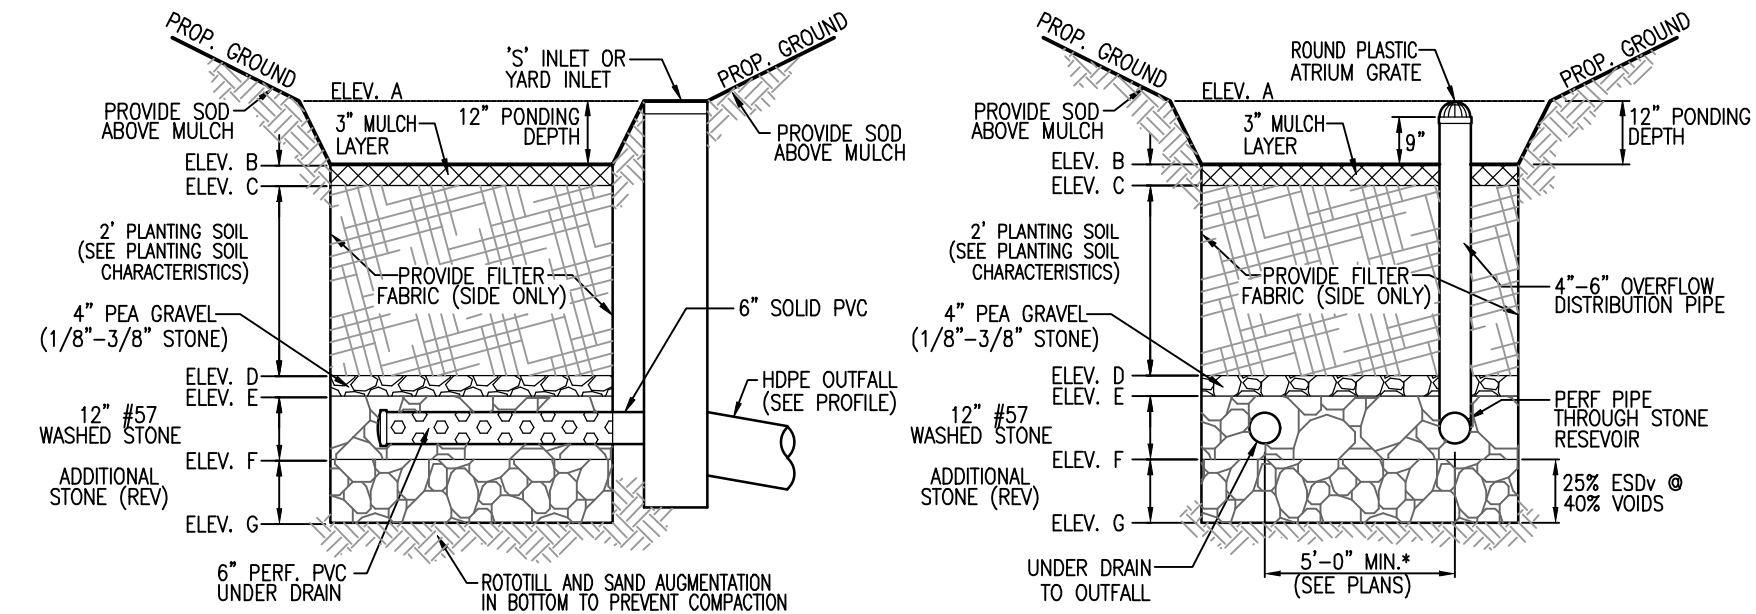


MICRO-BIORETENTION (UNDERDRAIN) (M-6) MICRO-BIORETENTION (OVERFLOW) (M-6)

OPERATION AND MAINTENANCE SCHEDULE FOR LANDSCAPE INFILTRATION (M-3), MICRO-BIORETENTION (M-6), RAIN GARDENS (M-7), BIORETENTION SWALE (M-8), AND ENHANCED FILTERS (M-9)
1. THE OWNER SHALL MAINTAIN THE PLANT MATERIAL, MULCH LAYER AND SOIL LAYER ANNUALLY...
2. THE OWNER SHALL PERFORM A PLANT IN THE SPRING AND IN THE FALL OF EACH YEAR...
3. THE OWNER SHALL INSPECT THE MULCH EACH SPRING...
4. THE OWNER SHALL CORRECT SOIL EROSION ON AN AS NEEDED BASIS...


MICROBIORETENTION NOTES:
1. ONLY THE SIDES OF MICROBIORETENTION ARE TO BE WRAPPED IN FILTER FABRIC...
2. WRAP THE PERFORATED MBR UNDERDRAIN PIPE WITH 1/4" MESH (4x4) OR SMALLER GALVANIZED HARDWARE CLOTH...
3. PROVIDE 5" MINIMUM SPACING BETWEEN UNDER DRAIN AND PERFORATED PIPE THROUGH STONE RESIVOIR OR SPADE PIPE EQUALLY ACROSS BOTTOM FOR SMALL BIOS.

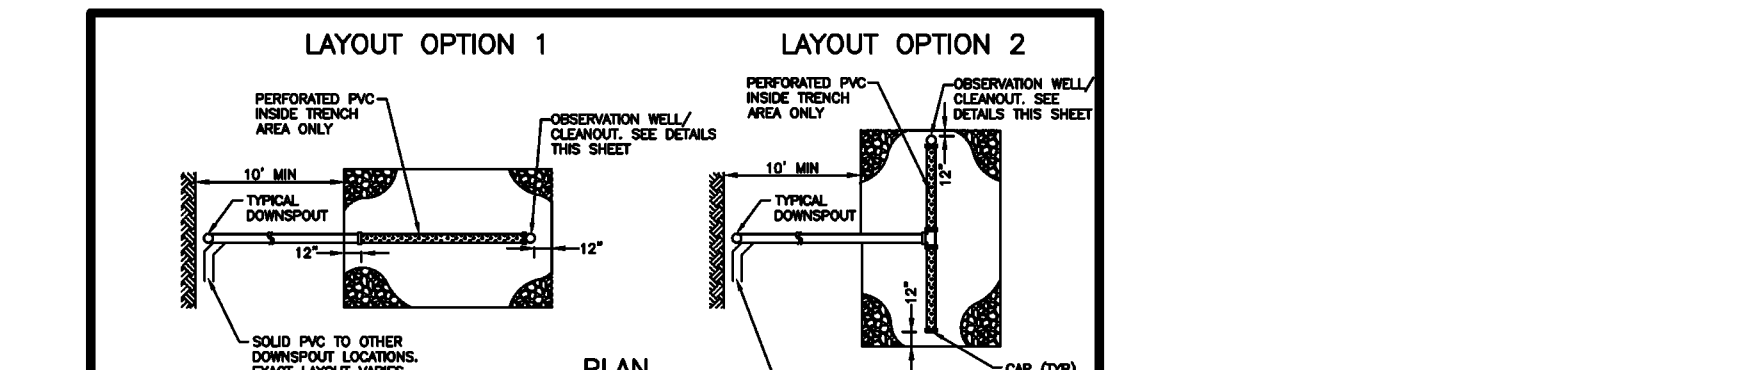

LAYOUT OPTION 1 LAYOUT OPTION 2 PLAN VIEW

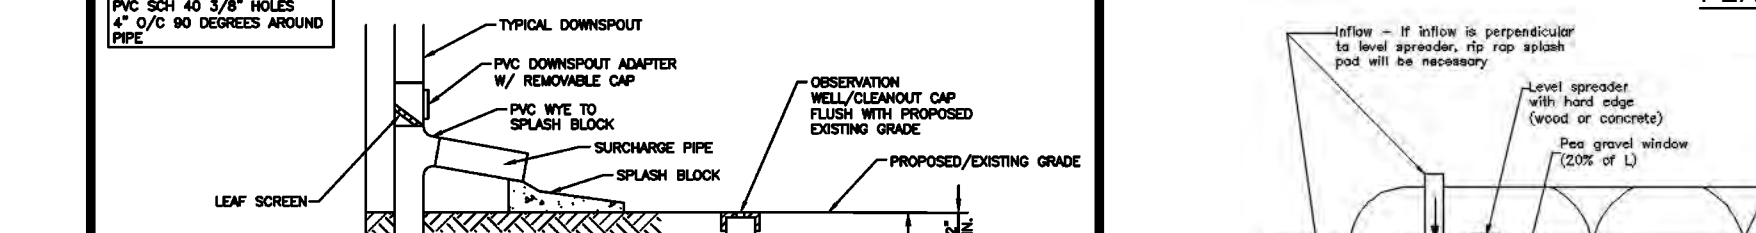

SUBMERGED GRAVEL WETLAND W/ PEA GRAVEL WINDOW PLAN VIEW

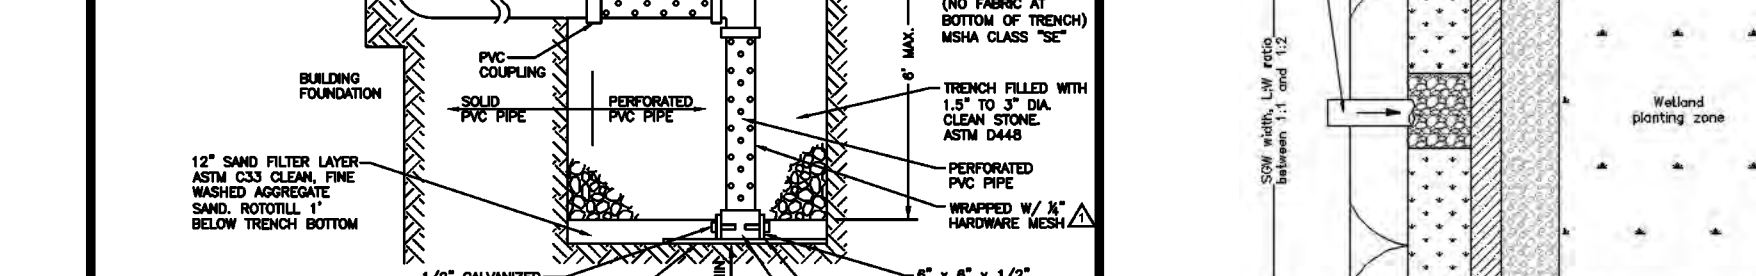


SUBMERGED GRAVEL WETLAND W/ PEA GRAVEL WINDOW PROFILE VIEW

NOTES:
1. UNADJUSTED SAND IS NOT ACCEPTABLE IN DRYWELLS...
2. SAND SHOULD BE SOFT AND 20% #100...
3. DRYWELLS MUST BE A MINIMUM OF 15' FROM BUILDING FOUNDATION...
4. TRENCH MAY NOT BE INSTALLED IN INFILTRATION.

HOWARD COUNTY, MARYLAND DEPARTMENT OF PUBLIC WORKS. PRIVATE. D-9.01

FIGURE 3 STANDARD DRYWELL DOWNSPOUT FITTINGS

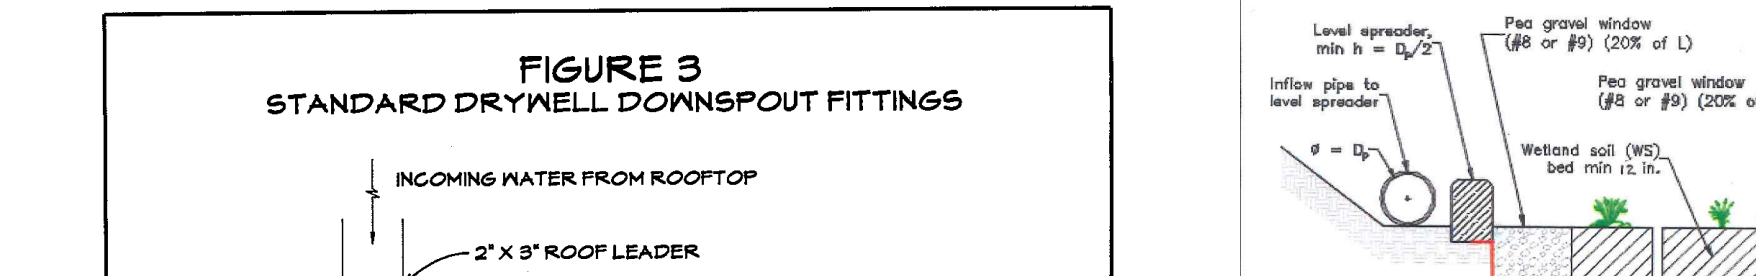

OPERATION AND MAINTENANCE SCHEDULE FOR PRIVATELY OWNED AND MAINTAINED STORMWATER DRY WELLS (M-5)
1. THE MONITORING WELLS AND STRUCTURES SHALL BE INSPECTED ON A QUARTERLY BASIS AND AFTER EVERY LARGE STORM EVENT.

CONSTRUCTION CRITERIA: THE FOLLOWING ITEMS SHOULD BE ADDRESSED DURING THE CONSTRUCTION OF PROJECTS WITH SUBMERGED GRAVEL WETLANDS:

- 1. SITE DISTURBANCE: ALL ON-SITE DISTURBED AREAS SHOULD BE STABILIZED PRIOR TO ALLOWING RUNOFF TO ENTER THE NEWLY CONSTRUCTED WETLAND.
2. EROSION AND SEDIMENT CONTROL: THE PROPOSED LOCATION OF A SUBMERGED GRAVEL WETLAND SHALL BE PROTECTED DURING CONSTRUCTION...
3. GRAVEL MEDIA: THE AGGREGATE SHALL BE COMPOSED OF AN 18 TO 48 INCH LAYER OF CLEAN WASHED, UNIFORMLY GRADED MATERIAL WITH A POROSITY OF 40%.

WETLAND CONSTRUCTION SHALL BE PERFORMED WITH LIGHTWEIGHT, WIDE-TRACKED EQUIPMENT TO MINIMIZE DISTURBANCE AND COMPACTION.


INSPECTION: REGULAR INSPECTIONS SHALL BE MADE DURING THE FOLLOWING STAGES OF CONSTRUCTION:

- A. DURING EXCAVATION TO SUBGRADE.
B. DURING PLACEMENT OF BACKFILL OF PERFORATED INLET PIPE AND OBSERVATION WELLS.
C. DURING PLACEMENT OF GEOTEXTILES AND ALL FILTER MEDIA.
D. DURING CONSTRUCTION OF ANY APPURTENANCE CONVEYANCE SYSTEMS SUCH AS DIVERSION STRUCTURES, INLETS, OUTLETS, AND FLOW DISTRIBUTION STRUCTURES.
E. UPON COMPLETION OF FINAL GRADING AND ESTABLISHMENT OF PERMANENT STABILIZATION, AND BEFORE ALLOWING RUNOFF TO ENTER THE WETLAND.

CASCADE RIDGE - ESDv COMPUTATIONS table with columns for DA, Rv, DA, DA, MINIMUM VOLUME, MAXIMUM VOLUME, 1.5\"/>

MEASURED PROJECT TOTALS: 22.84, 0.2556, 330360, 7.35, 10575, 11425, 73171, 1.68, 5.67

NOTES:
(1) PROVIDE "GRAVEL JACKET" THROUGH SOIL LAYER TO KEEP SOIL FROM MIGRATING INTO TO GRAVEL LAYER.
(2) SLOTTED RIGID PVC OR HDPE OR PERFORATED SOH 40 PVC PIPE TO BE WRAPPED W/ 1/4\"/>

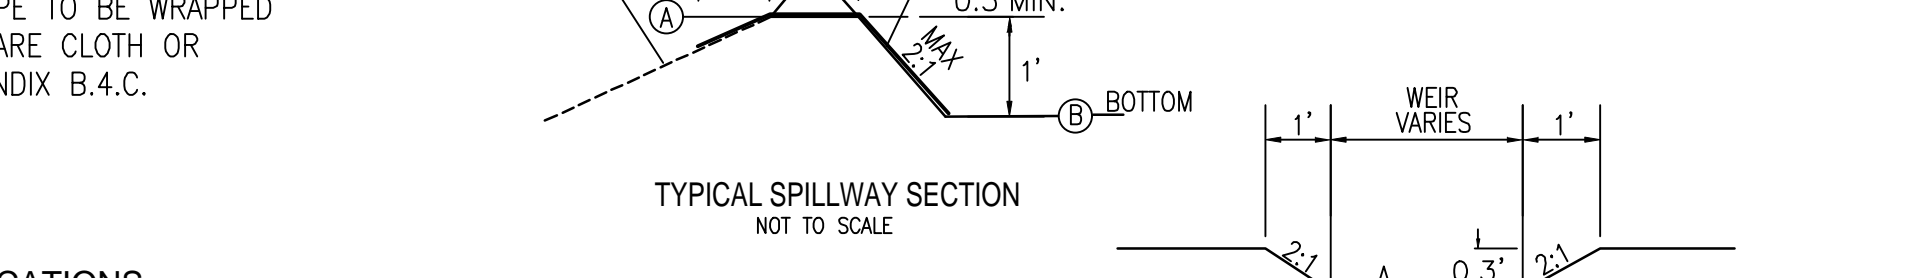

TYPICAL SPILLWAY SECTION NOT TO SCALE. DETAILS OF WEIR OUTLET MICRO-BIORETENTION NOT TO SCALE.

WETLAND SOIL SPECIFICATIONS: THE SURFACE INFILTRATION RATES OF THE GRAVEL WETLAND SOIL SHOULD BE SIMILAR TO A LOW HYDRAULIC CONDUCTIVITY WETLAND SOIL.

IMPERVIOUS LINER: IF NATIVE A LOW HYDRAULIC CONDUCTIVITY NATIVE SOIL IS NOT PRESENT BELOW THE GRAVEL LAYER, A LOW PERMEABILITY LINER OR SOIL SHOULD BE USED TO:

Table with columns for NO., REVISION, DATE.

PRELIMINARY EQUIVALENT SKETCH PLAN STORMWATER MANAGEMENT DETAILS. CASCADE RIDGE. VOGEL ENGINEERING + TIMMONS GROUP. Includes project location, engineer info, and certification.